

GENERAL SPECIFICATION :-

FOUNDATION : PLAIN CEMENT CONCRETE AS PER DESIGN.
: R.C.C. COLUMN FOOTING & COLUMN AS PER STRUCTURAL DESIGN.

SUPER STRUCTURE : R.C.C. COLUMN AND BEAM AS PER STRUCTURAL DESIGN.
: 0.23M THK. EXTERNAL WALL & 0.11M THK. PARTITION WALL.
: IN CEMENT MORTAR.
: R.C.C. ROOF SLAB AS PER STRUCTURAL DESIGN.

FLOOR : J.P.S FLOORING ON P.C.C. BED ALL OVER FLOOR

INTERNAL FINISH : WHITE WASHING OVER CEMENT PLASTER

SANITARY : VITROUS CHAINA SANITARY WARE
: G.I. PIPE WATER SUPPLY.
: C.I. PIPE FOR DISPOSAL.

DOORS & WINDOWS : AS PER SCHEDULE

ELECTRICAL : COPPER CONDUCTOR WITH P.V.C. CONDUIT.





PROPOSED RESIDENTIAL BUILDING FOR :

1. MRS. PUTUL KUMARI
W/O SHREE AWADH KISHORE SINGH

2. MR. UJJWAL KISHORE
S/O SHREE AWADH KISHORE SINGH

PLOT NO. :1215
SUB PLOT NO. :C-5
KHATA NO. :208
THANA : ADITYAPUR
THANA NO :131
MAUZA : ASANGI
DISTRICT : EAST SINGHBHUM
DIST. : SERAIKELA KHARSWAN

ALL FLOOR PLAN SECTION & ELEVATION DRG.

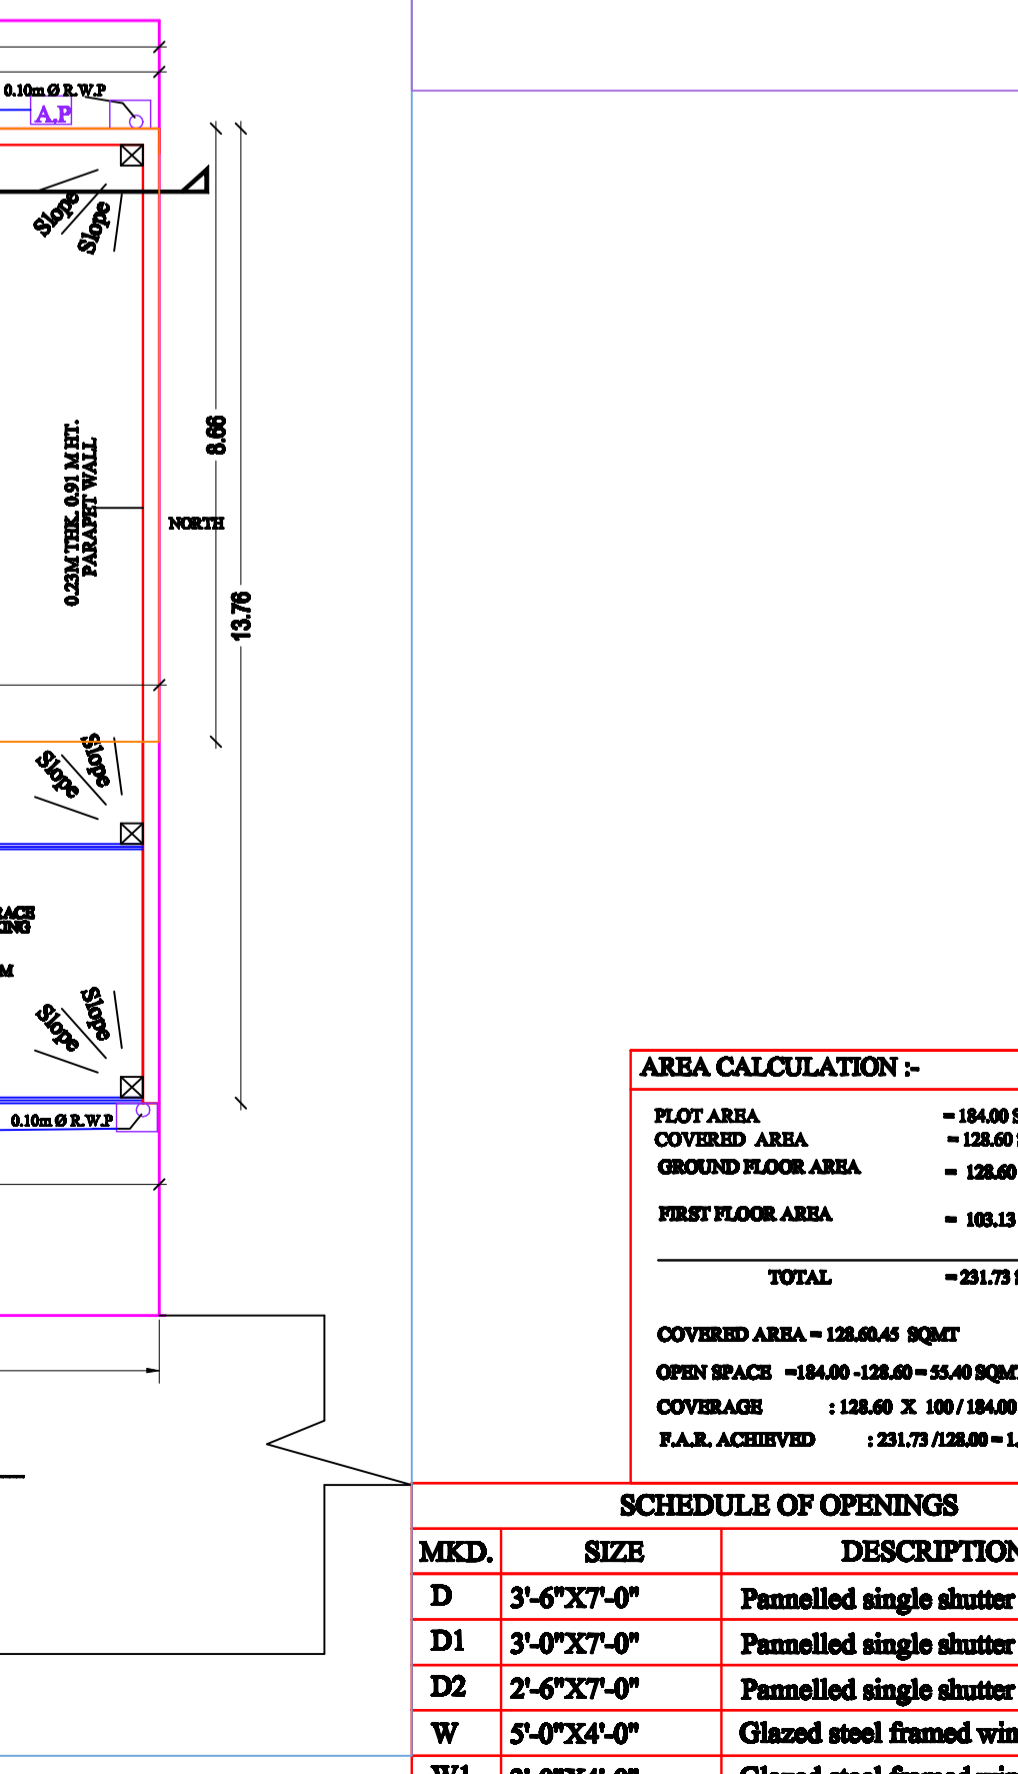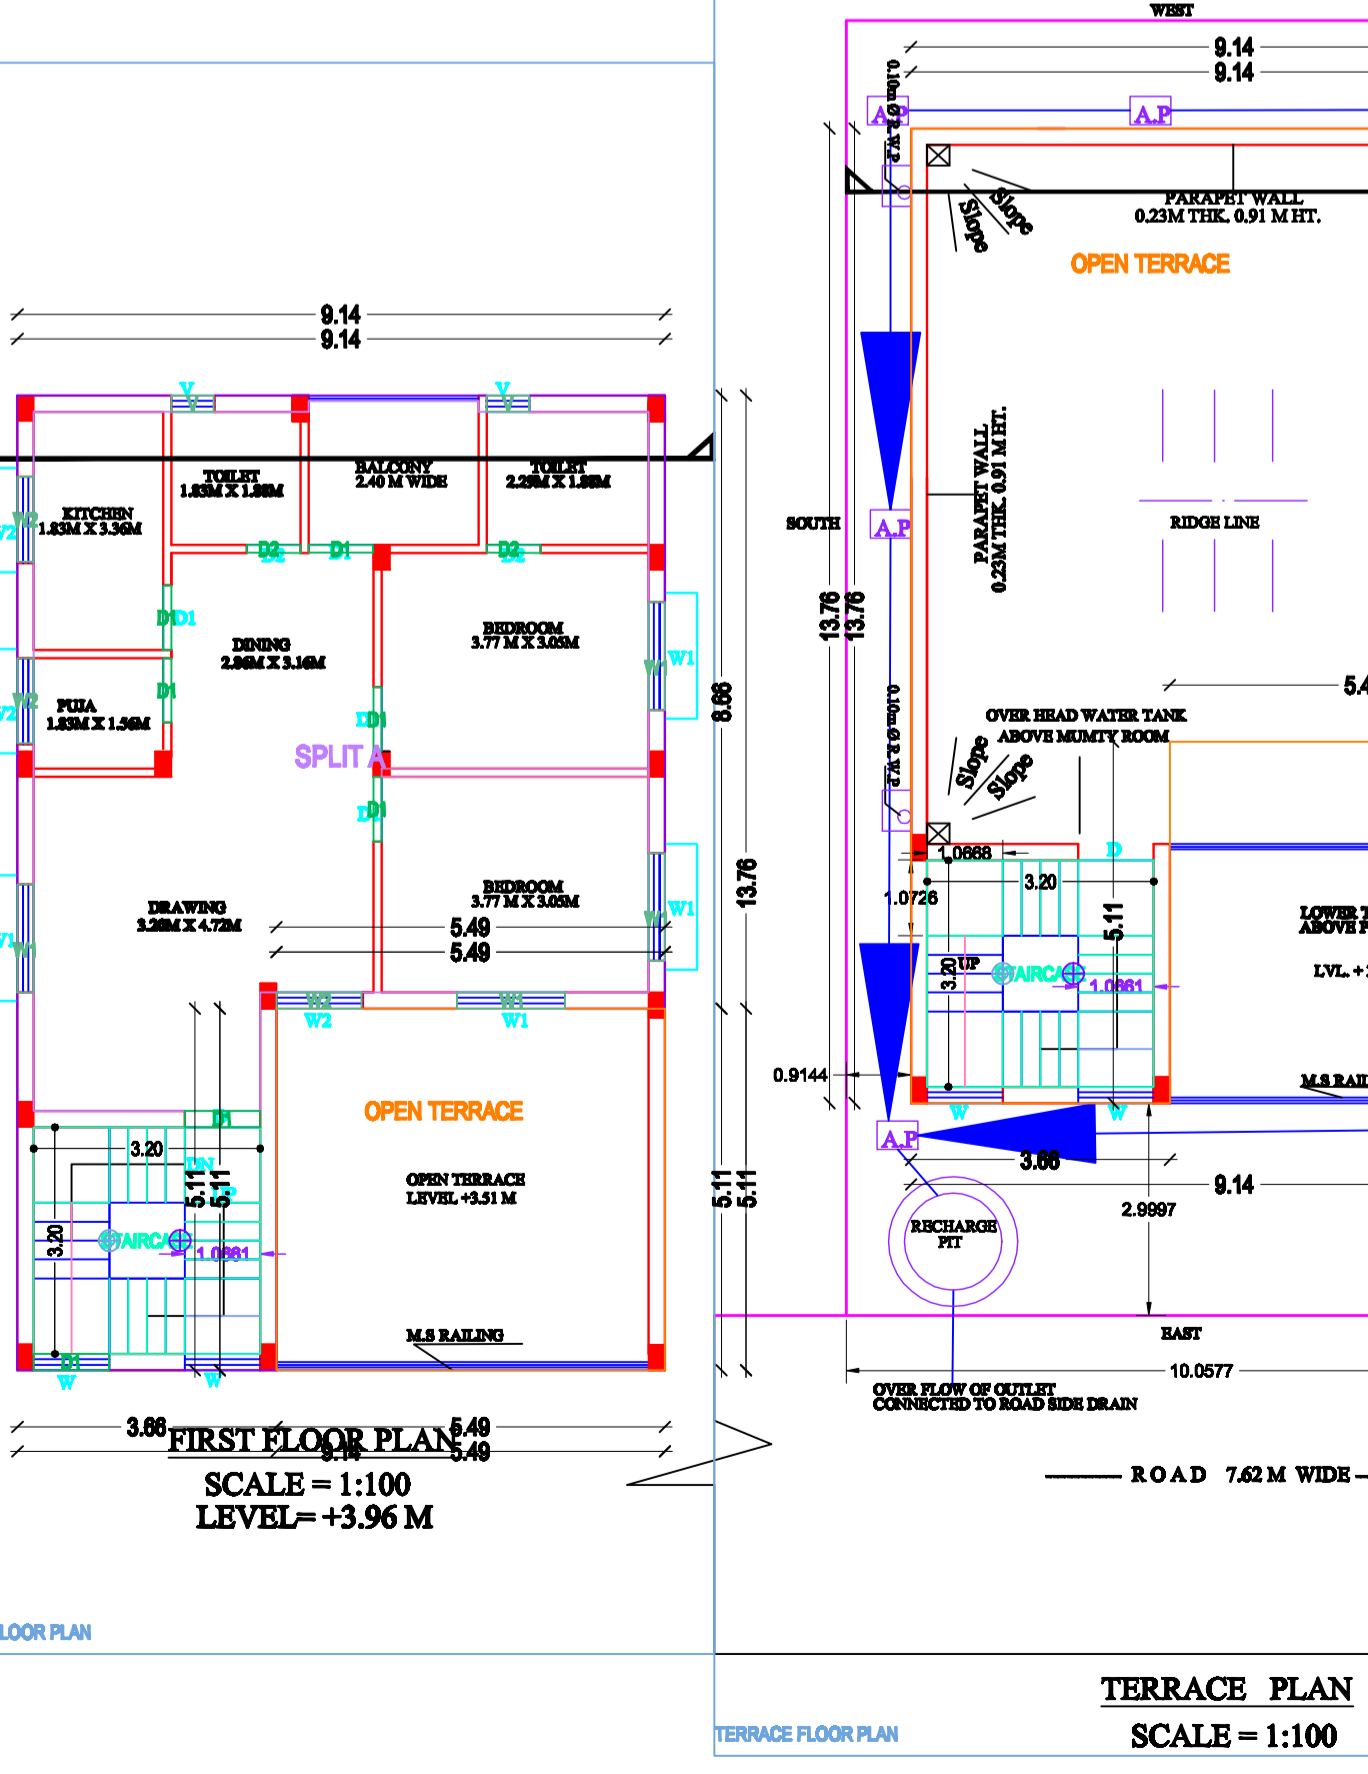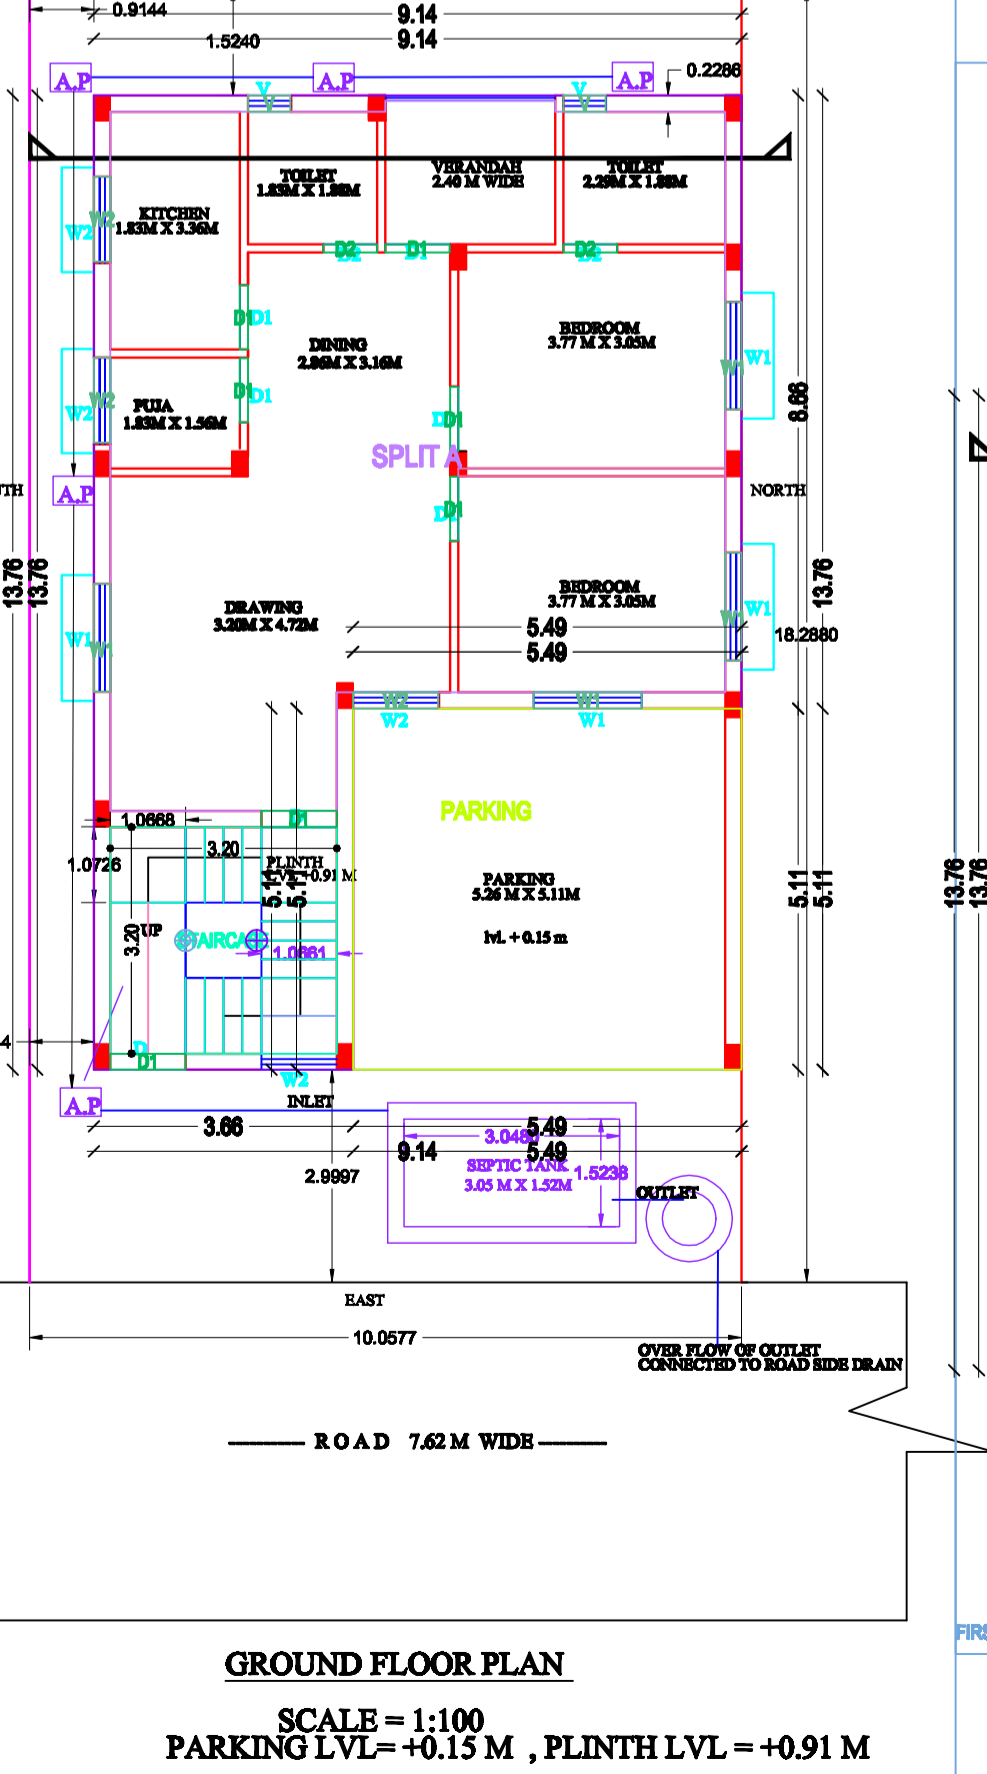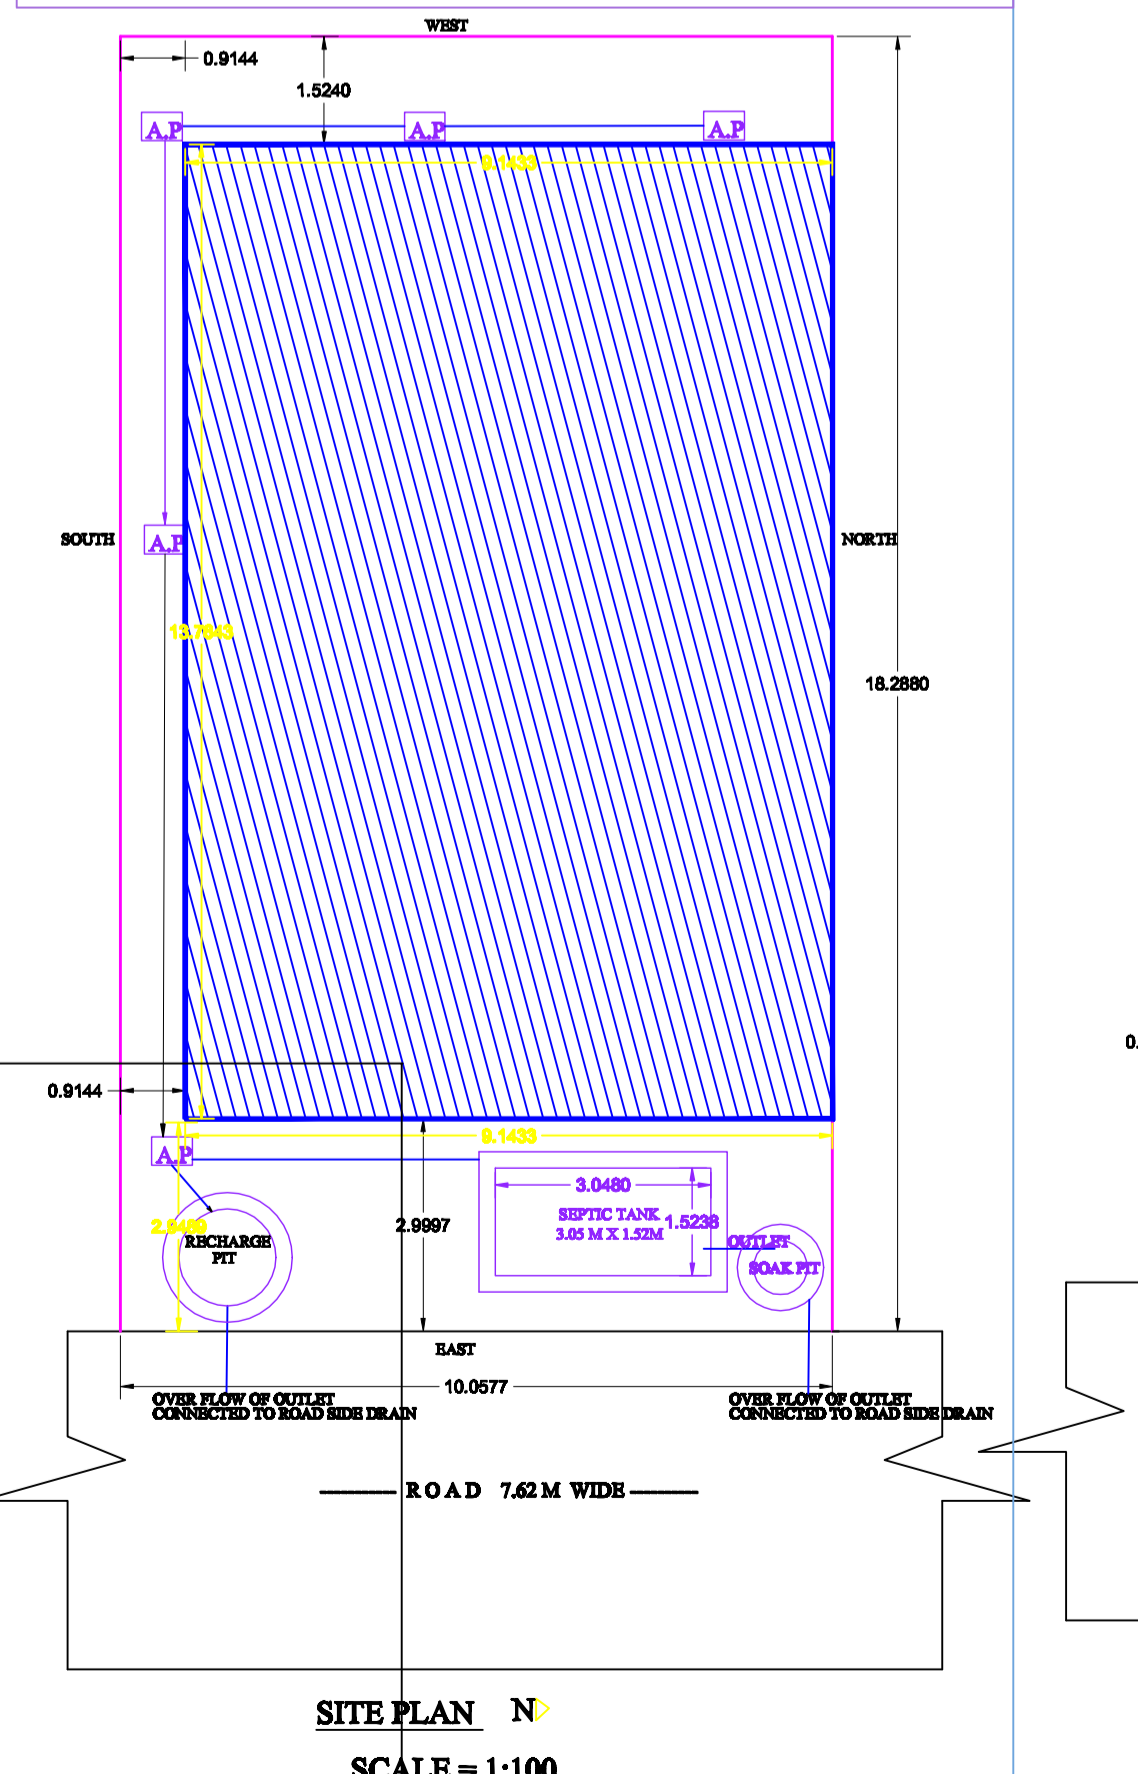

SIGNATURE OF ARCHITECT / ENGINEER

SCALE : 1:100, 1:200 SHEET NO.- 1 OF 1

AREA CALCULATION :-

PLOT AREA	= 184.00 SQM
COVERED AREA	= 128.60 SQM
GROUND FLOOR AREA	= 128.60 SQM
FIRST FLOOR AREA	= 105.13 SQM
TOTAL	= 233.73 SQM
COVERED AREA	= 128.60 SQM
OPEN SPACE	= 184.00 - 128.60 = 55.40 SQM
COVERAGE	: 128.60 X 100 / 184.00 = 69.86 %
F.A.R. ACHIEVED	: 231.73 / 128.60 = 1.26

SCHEDULE OF OPENINGS

MKD.	SIZE	DESCRIPTION
D	3'-6"X7'-0"	Pannelled single shutter door.
D1	3'-0"X7'-0"	Pannelled single shutter door.
D2	2'-6"X7'-0"	Pannelled single shutter door.
W	5'-0"X4'-0"	Glazed steel framed window 3. shutt.
W1	3'-0"X4'-0"	Glazed steel framed window 2. shutt.
V	2'-0"X2'-0"	Top hung steel ventilator.
V1	1'-3"X2'-0"	Top hung steel ventilator.

SIGNATURE OF OWNER

APPROVED AUTHORITY (A.M.C)