



#### FOOTING SCHEDULE (M30:Fe500)

FOOTING	OOL LINAN!	DEDECTAL		FOOTII	NG DIME	NSION		FOOTING REIN	FORCEMENT
FOOTING	COLUMN	PEDESTAL	OTED		Б	D4	Do	ВОТ	TOM
NUMBERS	NUMBERS	SIZE	STEP	L	В	D1	D2	ALONG (B)	ALONG (L)
F1	C1	800x1200	-	1500	1500	550	225	T16@125 C/C	T16@125 C/C
F2	C4	1000x1200	-	1750	1750	550	300	T16@125 C/C	T16@125 C/C
F3	C2,C3	1400x1000	-	2800	1900	600	300	T16@125 C/C	T16@125 C/C
F4	C9	550x1800	-	2400	2400	750	350	T16@125 C/C	T16@125 C/C
F5	C8	1800x1800	-	3000	3000	450	225	T16@125 C/C	T16@125 C/C
F6	C11	1800x1800	-	3200	3200	500	300	T16@125 C/C	T16@125 C/C
F7	C12	2000x2000	-	3400	3400	500	250	T16@125 C/C	T16@125 C/C
F8	C10,C15	2300x2300	-	3650	3650	500	250	T16@125 C/C	T16@125 C/C
F9	C7	2200x2200	-	3900	3900	600	300	T16@125 C/C	T16@125 C/C
F10	C6	2300x2500	-	4300	4300	650	400	T16@125 C/C	T16@125 C/C
F11	C14	3000x3000	-	5100	5100	800	400	T16@125 C/C	T16@125 C/C
F12	C13	3000x3000	-	5500	5500	900	450	T16@100 C/C	T16@100 C/C
F13	C5, LIFT	-		4500	5000	750	750	T16@100 C/C	T16@100 C/C

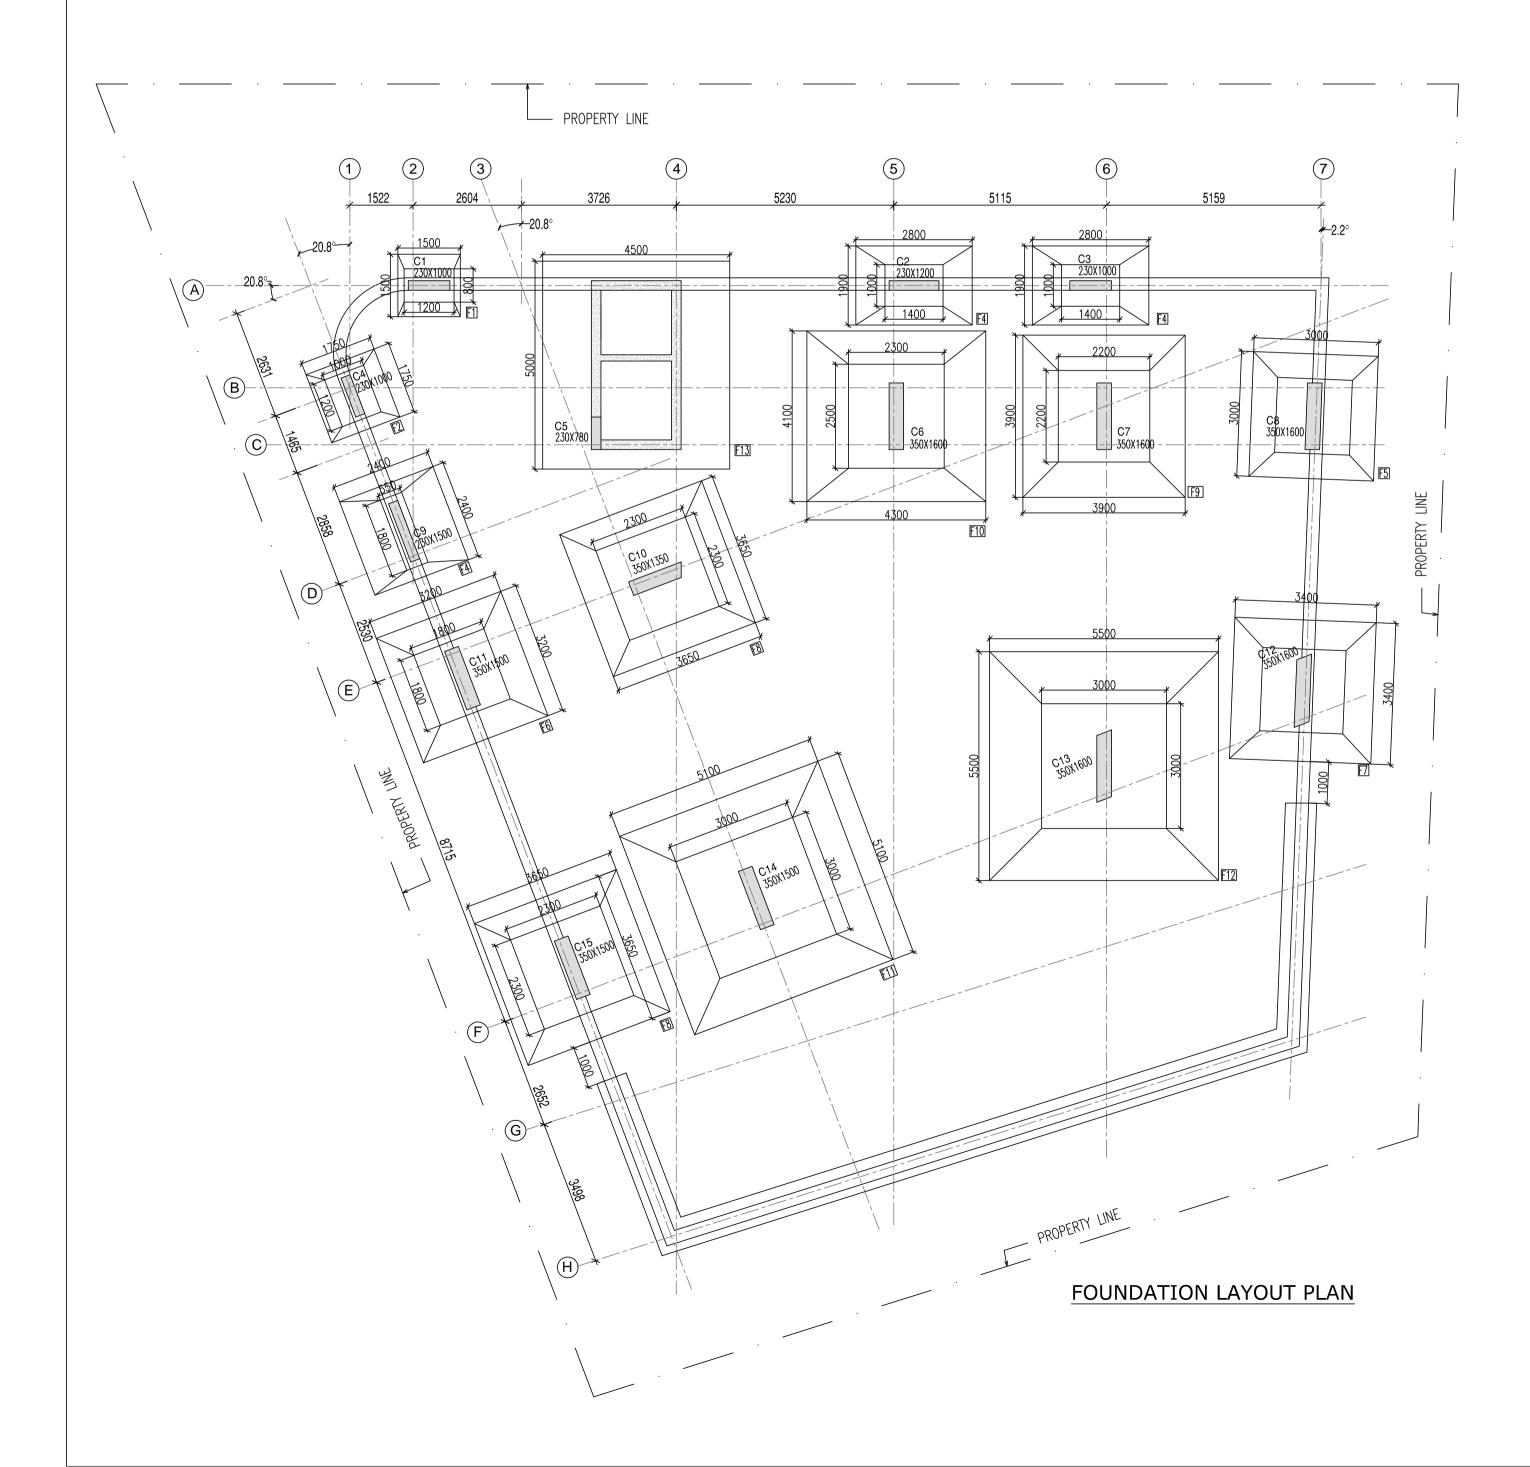

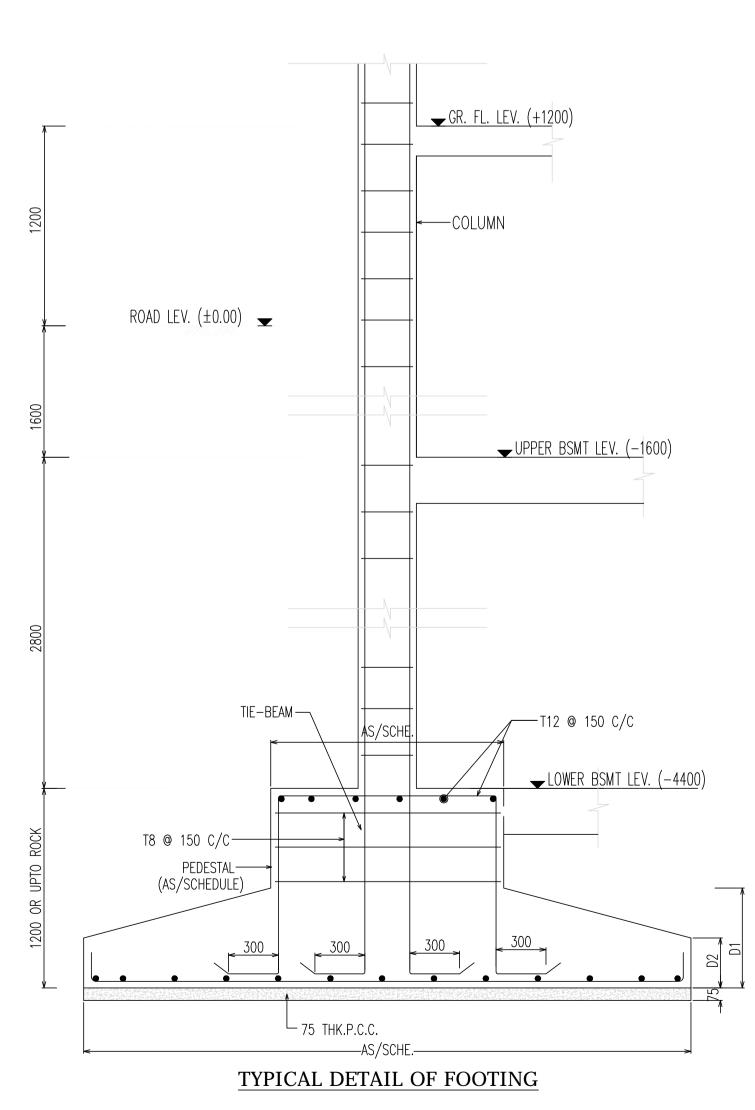

### <u>NOTES:-</u>

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- 2. SUPER STRUCTURE : SUPER STRUCTURE SHALL BE OF 1ST CLASS BRICK IN 1:6 CEMENT MORTAR.
- 3. ALL GRADE OF CONCRETE M-30.
- 4. ALL MATERIALS SHALL CONFORM TO RELEVANT I.S CODES.
- 5. FOR STEEL GRADE Fe 500 AS PER I.S 1786-1979.
- 6. LAPS, SPLICES & BOND LENGTH SHOULD BE 50 D WHERE 'D' IS THE SMALLEST BAR DIA.
- 7. FOUNDATION & PLINTH: BRICKWORK IN FOUNDATION & PLINTH
- SHALL BE OF 1ST CLASSBRICK IN 1:6 CEMENT MORTAR.
- 8. MINIMUM CLEAR COVER TO MAIN REINFORCEMENT IS AS FOLLOWS: MEMBER SIDE
- a. STUB COLUMN
- b. BAND BEAM.

25

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- 10. THIS DRAWING IS TO BE READ IN CONJUNCTION WITH THE FOLLOWING ARCHITECTURAL DRAWINGS -

REVISION	NO	DATE
ISSUED FOR		

# OWNER

PROJECT PROPOSED ADRESHA MALL AT SAKCHI, JAMSHEDPUR

FOUNDATION LAYOUT PLAN, SCHEDULE AND DETAILS

ARCHITECTS

VINEET SINHA ARCHITECTS

1A, FIRST FLOOR, 'SMRITI', 8th AVENUE BISTUPUR, JAMSHEDPUR 831001 PH:2424998, FAX: 2424777

STRUCTURAL ENGINEERS

34, RAM MOHAN DUTTA ROAD KOLKATA – 700020 .

PH. NO 2485-5448/5449,2475-7614(Tel.Fax)

E-mail: spa\_cons@yahoo.co.in DRAWN BY- CHECKED BY- DATE-KHOKAN PRITHWISH 24.08.18

SCALE: 1: 100,25 JOB NO. | 2018 | 07 | V.S. | SPA/53-II | ADRESHA MALL


DRG. NO. | 2018 /07/V.S./SPA/53-II/ADRESHA MALL/ST-01/R0

## **COLUMN SCHEDULE**

	MATERIAL	M30:Fe500						
ROOF	STEEL	12-T12 + 6-T12	32-T12	16-T12 + 6-T12	16-T12 + 6-T12	16-T12 + 6-T12	16-T16 + 6-T16	16-T16 + 6-T16
ТО	LINKS	T8@125 C/C						
ABV RF	SIZE	230 X 1500	350 X 1350	350 X 1500	350 X 1600	350 X 1600	350 X 1500	350 X 1500
	MATERIAL	M30:Fe500						
4TH FL	STEEL	12-T12 + 6-T12	32-T12	16-T12 + 6-T12	16-T12 + 6-T12	16-T12 + 6-T12	16-T16 + 6-T16	16-T16 + 6-T16
ТО	LINKS	T8@125 C/C						
ROOF	SIZE	230 X 1500	350 X 1350	350 X 1500	350 X 1600	350 X 1600	350 X 1500	350 X 1500
2ND FL	MATERIAL	M30:Fe500						
ТО	STEEL	12-T12 + 6-T12	32-T12	16-T12 + 6-T12	16-T12 + 6-T12	16-T20 + 6-T16	16-T20 + 6-T12	16-T12 + 6-T12
	LINKS	T8@125 C/C						
4TH FL	SIZE	230 X 1500	350 X 1350	350 X 1500	350 X 1600	350 X 1600	350 X 1500	350 X 1500
ODEL	MATERIAL	M30:Fe500						
GRFL	STEEL	12-T12 + 6-T12	32-T12	16-T12 + 6-T12	16-T12 + 6-T12	16-T32 + 6-T32	16-T32 + 6-T16	16-T12 + 6-T12
TO	LINKS	T8@125 C/C						
2ND FL	SIZE	230 X 1500	350 X 1350	350 X 1500	350 X 1600	350 X 1600	350 X 1500	350 X 1500
	MATERIAL	M30:Fe500						
BASE	STEEL	12-T12 + 6-T12	4-T16 + 28-T12	16-T12 + 6-T12	16-T12 + 6-T12	16-T32 + 6-T32	16-T32 + 6-T16	16-T12 + 6-T12
ТО	LINKS	T8@125 C/C						
GRFL	SIZE	230 X 1500	350 X 1350	350 X 1500	350 X 1600	350 X 1600	350 X 1500	350 X 1500
COLUMN	MARKED	C9	C10	C11	C12	C13	C14	C15

## COLUMN SCHEDULE

DOOF	MATERIAL	M30:Fe500	M30:Fe500						
ROOF	STEEL	12-T12 + 2-T12	12-T12 + 4-T12	12-T12 + 2-T12	12-T12 + 2-T12	14-T12	34-T12	34-T12	16-T12 + 6-T12
TO	LINKS	T8@125 C/C	T8@125 C/C						
ABV RF	SIZE	230 X 1000	230 X 1200	230 X 1000	230 X 1000	230 X 780	350 X 1600	350 X 1600	350 X 1600
4711.51	MATERIAL	M30:Fe500	M30:Fe500						
4TH FL	STEEL	12-T16 + 2-T12	12-T12 + 4-T12	12-T12 + 2-T12	12-T12 + 2-T12	14-T12	34-T12	34-T12	16-T12 + 6-T12
TO	LINKS	T8@125 C/C	T8@125 C/C						
ROOF	SIZE	230 X 1000	230 X 1200	230 X 1000	230 X 1000	230 X 780	350 X 1600	350 X 1600	350 X 1600
OND EI	MATERIAL	M30:Fe500	M30:Fe500						
2ND FL	STEEL	12-T20 + 2-T12	12-T16 + 4-T12	12-T16 + 2-T12	12-T12 + 2-T12	14-T12	34-T12	34-T12	16-T12 + 6-T12
TO	LINKS	T8@125 C/C	T8@125 C/C						
4TH FL	SIZE	230 X 1000	230 X 1200	230 X 1000	230 X 1000	230 X 780	350 X 1600	350 X 1600	350 X 1600
ODEL	MATERIAL	M30:Fe500	M30:Fe500						
GRFL	STEEL	12-T20 + 2-T16	12-T16 + 4-T12	12-T20 + 2-T12	12-T12 + 2-T12	4-T16 + 12-T12	4-T16 + 30-T12	34-T12	16-T12 + 6-T12
TO	LINKS	T8@125 C/C	T8@125 C/C						
2ND FL	SIZE	230 X 1000	230 X 1200	230 X 1000	230 X 1000	230 X 780	350 X 1600	350 X 1600	350 X 1600
	MATERIAL	M30:Fe500	M30:Fe500						
BASE	STEEL	12-T20 + 2-T16	12-T12 + 4-T12	12-T20 + 2-T12	12-T12 + 2-T12	4-T16 + 14-T12	8-T20 + 30-T16	12-T16 + 26-T12	16-T16 + 6-T12
ТО	LINKS	T8@125 C/C	T8@125 C/C						
GRFL	SIZE	230 X 1000	230 X 1200	230 X 1000	230 X 1000	230 X 780	350 X 1600	350 X 1600	350 X 1600
COLUMN	N MARKED	C1	C2	C3	C4	C5	C6	C7	C8

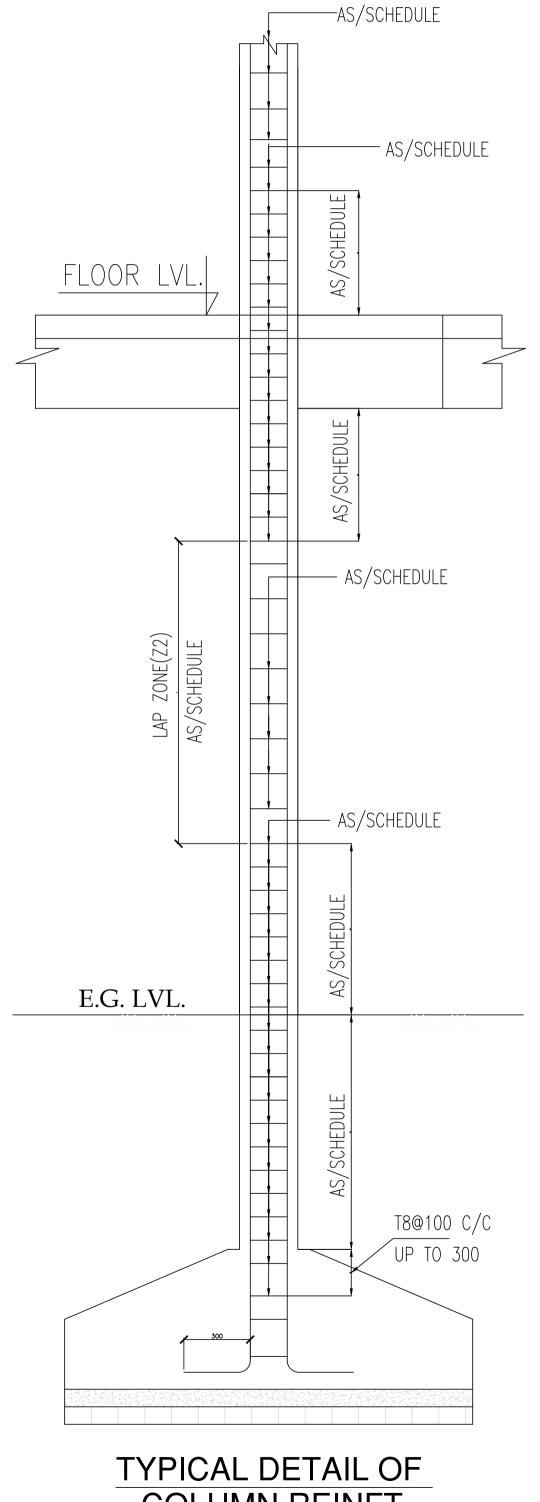

# NOTES:-

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- 8. MINIMUM CLEAR COVER TO MAIN REINFORCEMENT IS AS FOLLOWS: MEMBER SIDE

a. STUB COLUMN

b. BAND BEAM.

PERMISSION.

20

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REVISION	NO	DATE

ISSUED FOR

OWNER

PROJECT

PROPOSED ADRESHA MALL AT SAKCHI, JAMSHEDPUR

TITLE

## COLUMN SCHEDULE AND DETAILS

# ARCHITECTS

# VINEET SINHA ARCHITECTS

1A, FIRST FLOOR, 'SMRITI', 8th AVENUE BISTUPUR, JAMSHEDPUR 831001 PH:2424998, FAX: 2424777

STRUCTURAL ENGINEERS

34, RAM MOHAN DUTTA ROAD

KOLKATA - 700020

PH. NO 2485-5448/5449,2475-7614(Tel.Fax) E-mail: spa\_cons@yahoo.co.in

DRAWN BY- CHECKED BY-KHOKAN

DATE-PRITHWISH 24.08.18 2018 07 V.S.


SCALE: 1: 25 SPA/53-II | ADRESHA MALL


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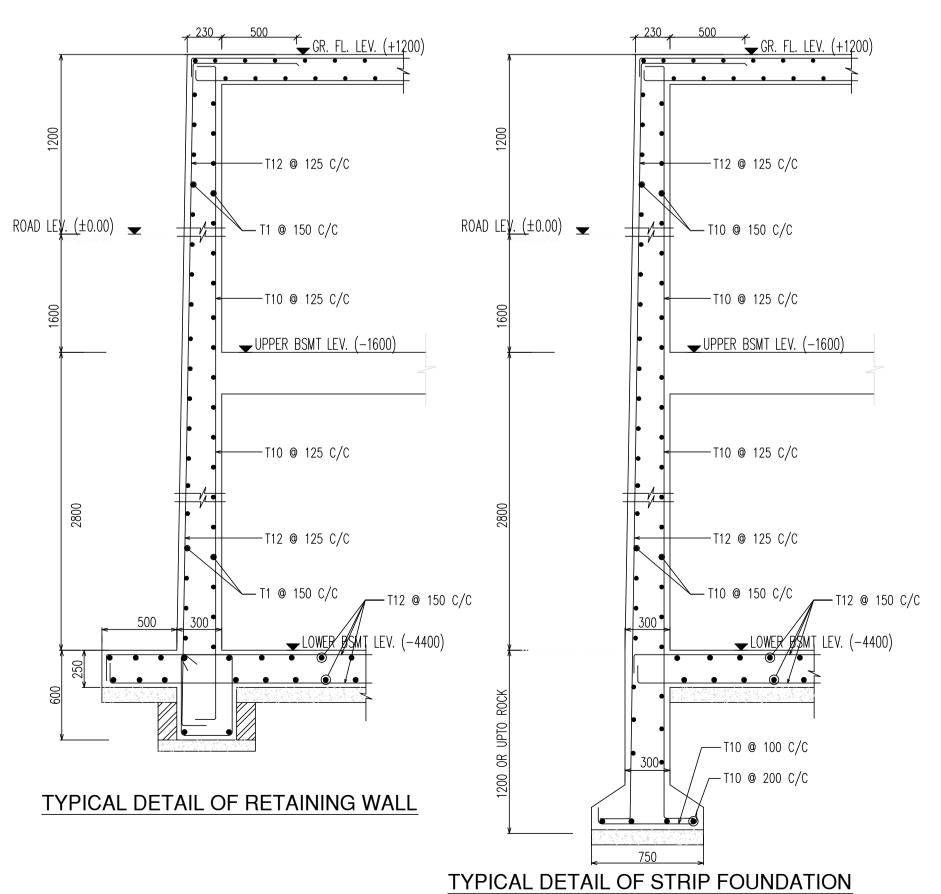
JOB NO.

2018 /07/V.S./SPA/53-II/ADRESHA MALL/ST-02/R0

COLUMN REINFT.



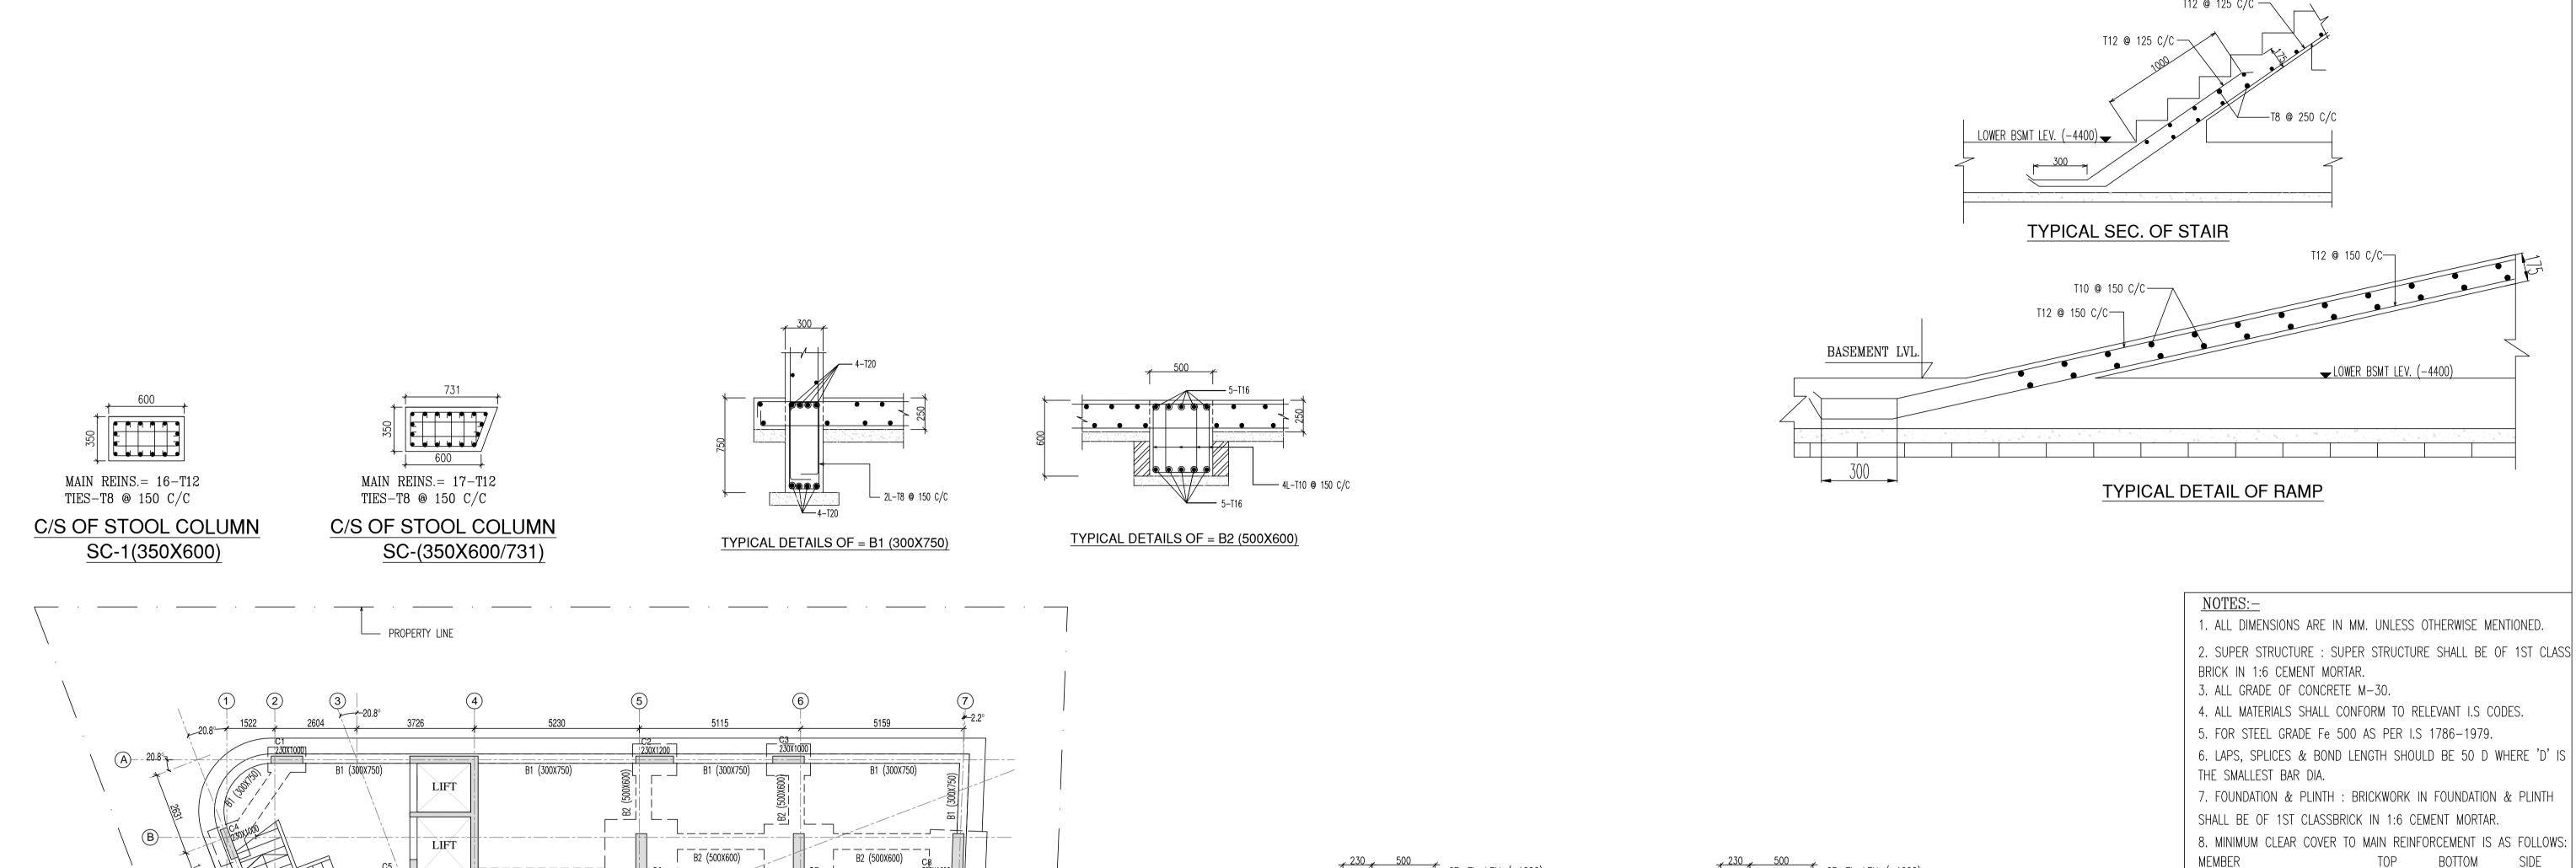

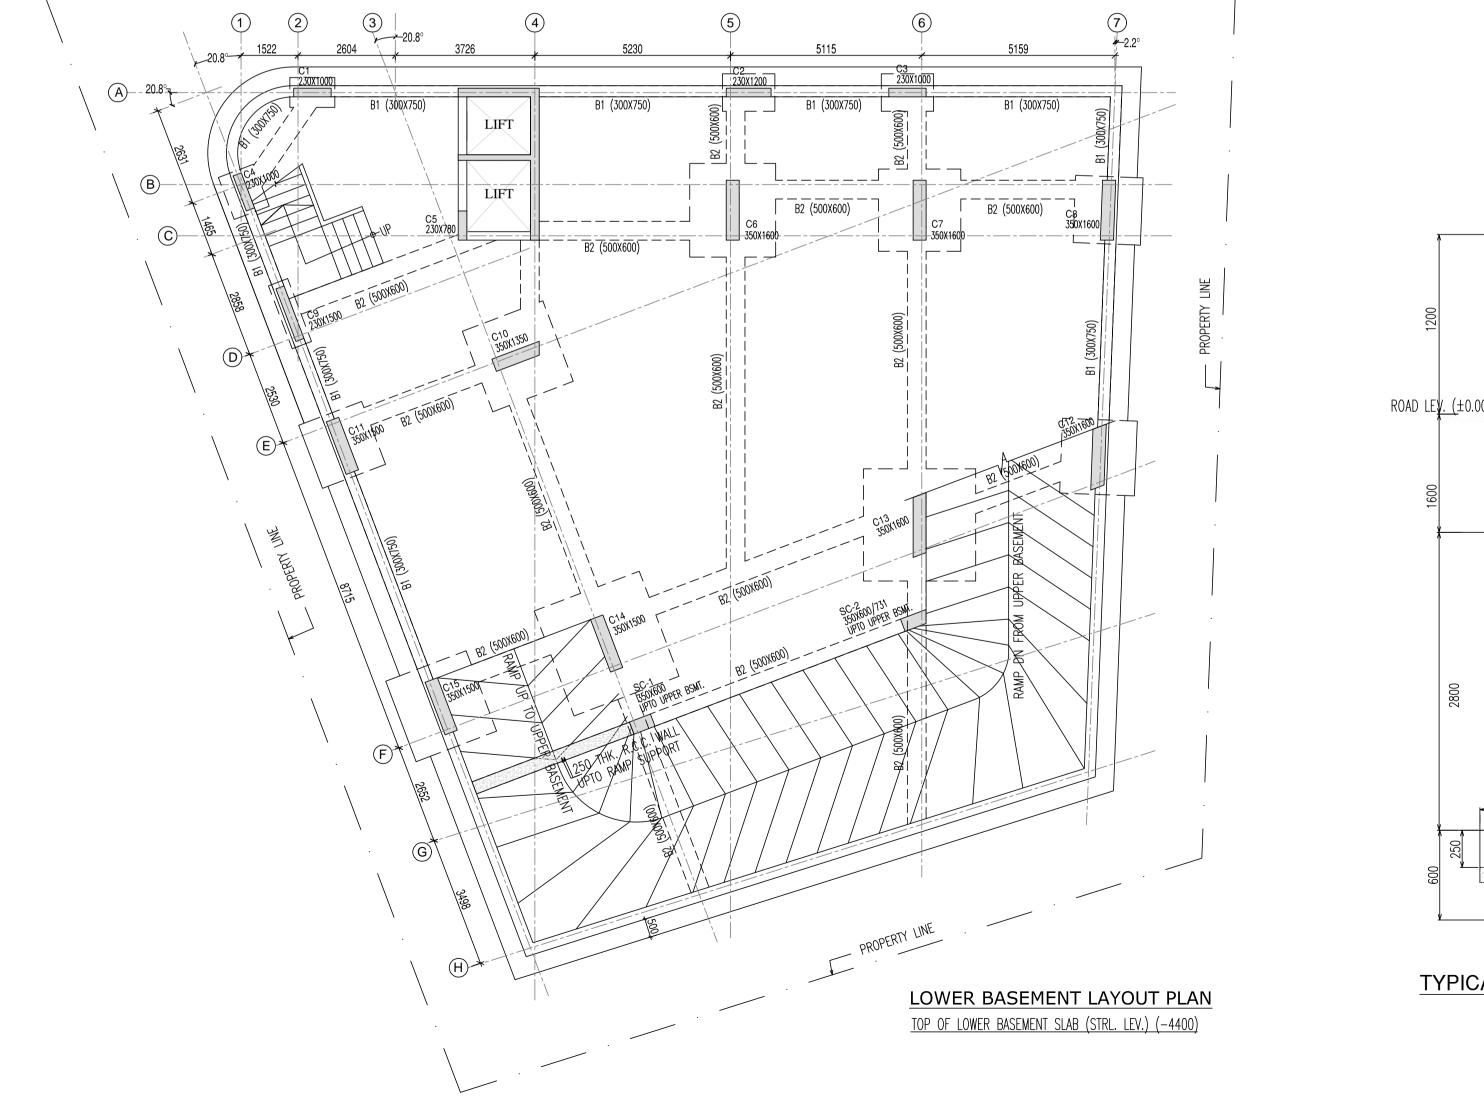

SHALL BE OF 1ST CLASSBRICK IN 1:6 CEMENT MORTAR.

8. MINIMUM CLEAR COVER TO MAIN REINFORCEMENT IS AS FOLLOWS MEMBER

TOP BOTTOM SIDE

a. STUB COLUMN

25

b. BAND BEAM.

20

20

20

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OWNER

PROJECT
PROPOSED ADRESHA MALL AT SAKCHI,
JAMSHEDPUR

LOWER BASEMENT LAYOUT
PLAN AND DETAILS

ARCHITECTS

VINEET SINHA ARCHITECTS

1A, FIRST FLOOR, 'SMRITI', 8th AVENUE
BISTUPUR, JAMSHEDPUR 831001
PH:2424998, FAX: 2424777

STRUCTURAL ENGINEERS
S.P.A.CONSULTANTS
34, RAM MOHAN DUTTA ROAD
KOLKATA - 700020 .
PH. NO 2485-5448/5449,2475-7614(Tel.Fax)
E-mail: spa\_cons@yahoo.co.in


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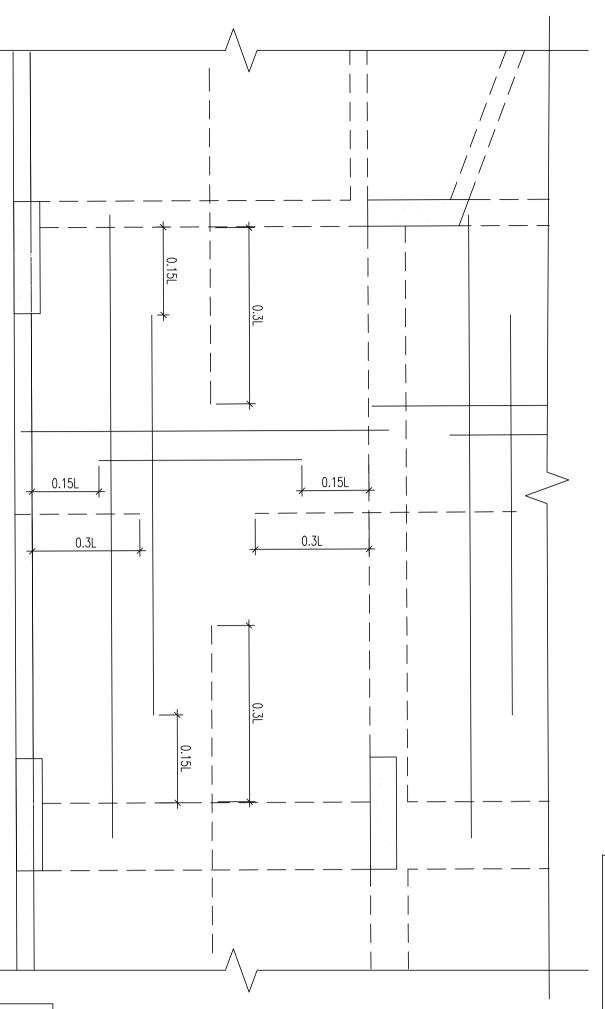
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JOB NO. 2018 07 V.S. SPA/53-II ADRESHA MALL

DRG. NO. 2018 07 V.S. SPA/53-II ADRESHA MALL

DRG. NO. 2018 /07/V.S./SPA/53-II/ADRESHA MALL/ST-03/R0



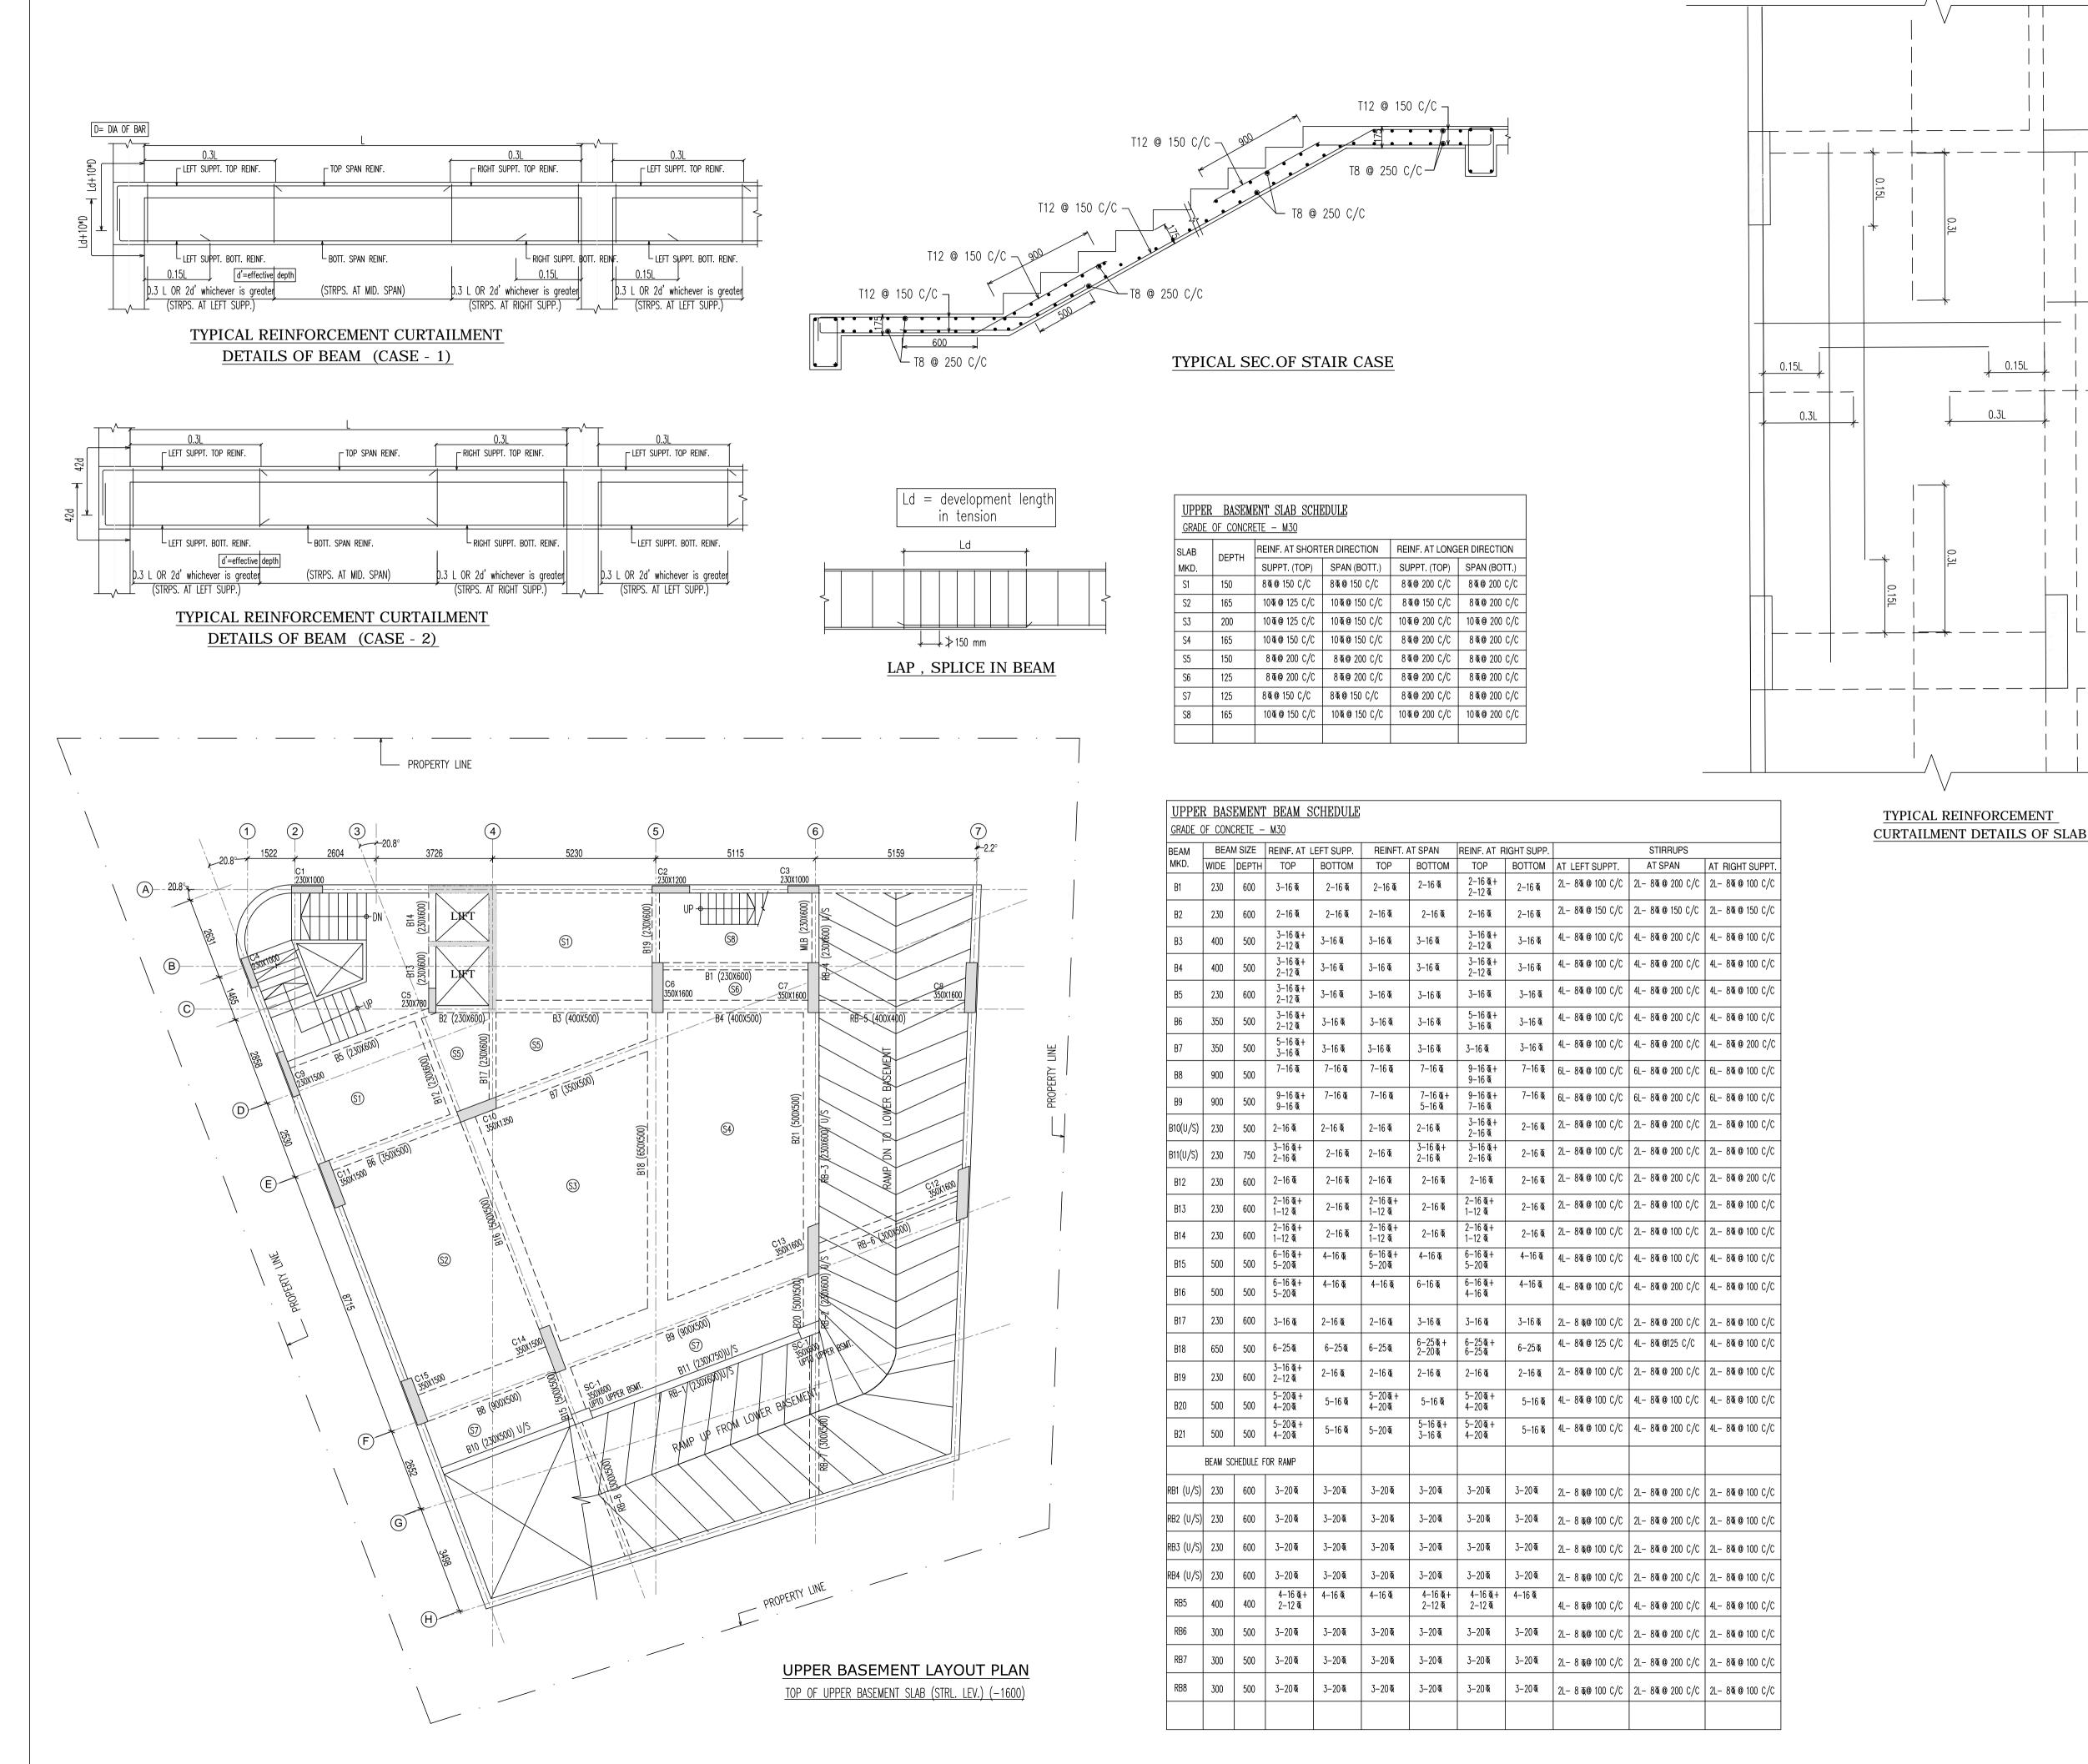

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8. MINIMUM CLEAR COVER TO MAIN REINFORCEMENT IS AS FOLLOWS:

MEMBER

a. STUB COLUMN

b. BAND BEAM.

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THE FOLLOWING ARCHITECTURAL DRAWINGS -

DATE REVISION

ISSUED FOR

OWNER

PROPOSED ADRESHA MALL AT SAKCHI,

JAMSHEDPUR

UPPER BASEMENT G.A. AND SCHEDULE

ARCHITECTS

VINEET SINHA ARCHITECTS 1A, FIRST FLOOR, 'SMRITI', 8th AVENUE BISTUPUR, JAMSHEDPUR 831001

PH:2424998, FAX: 2424777 STRUCTURAL ENGINEERS

34, RAM MOHAN DUTTA ROAD


KOLKATA - 700020 PH. NO 2485-5448/5449,2475-7614(Tel.Fax)


E-mail: spa\_cons@yahoo.co.in DRAWN BY- CHECKED BY- DATE-

KHOKAN PRITHWISH 24.08.18

JOB NO. | 2018 | 07 | V.S. | SPA/53-II | ADRESHA MALL DRG. NO. 2018 /07/V.S./SPA/53-II/ADRESHA MALL/ST-04/R0


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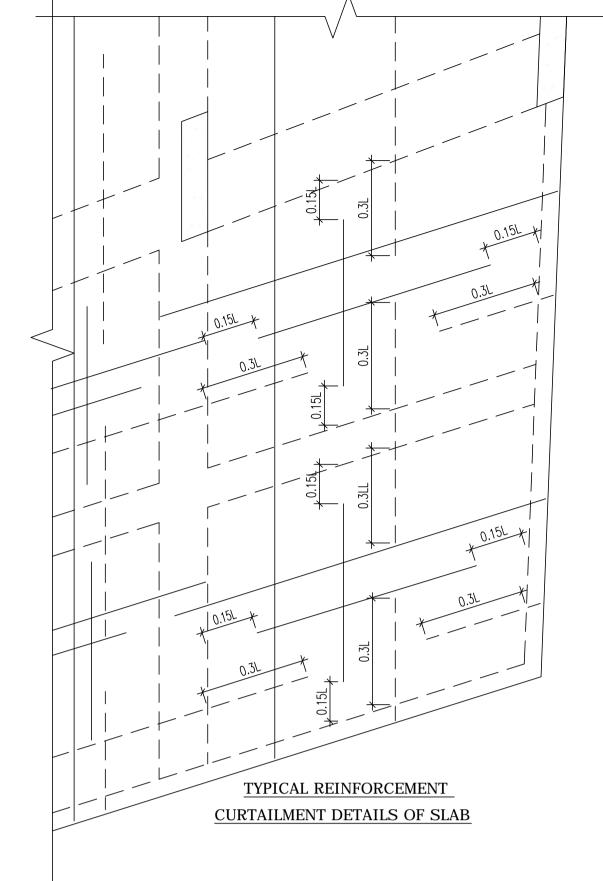


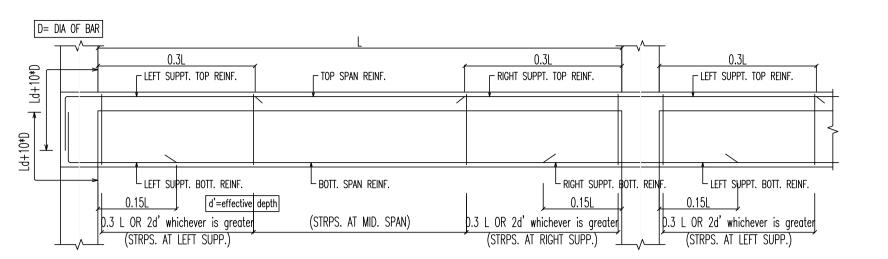


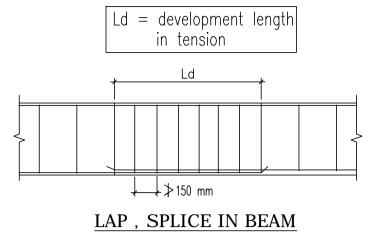T12 @ 150 C/C ¬

GROUND FLOOR SLAB SCHEDULE  GRADE OF CONCRETE - M30											
SLAB	DEPTH	REINF. AT SHORT	ER DIRECTION	REINF. AT LONG	ER DIRECTION						
MKD.	DEFIN	SUPPT. (TOP)	SPAN (BOTT.)	SUPPT. (TOP)	SPAN (BOTT.)						
S1	150	8 TQ @ 150 C/C	8 क @ 150 C/C	8 <b>4 0</b> 200 C/C	8 <b>क @</b> 200 C/C						
S2	165	10 <b>Q 0</b> 125 C/C	10 क @ 150 C/C	8 क @ 150 C/C	8 TQ 0 200 C/C						
S3	200	10 क @ 125 C/C	10 क @ 150 C/C	10 to @ 200 C/C	10 क @ 200 C/C						
S4	165	10 क @ 150 C/C	10 क @ 150 C/C	8 TQ @ 200 C/C	8 TQ 0 200 C/C						
S5	150	8 TQ @ 200 C/C	8 TQ @ 200 C/C	8 क @ 200 C/C	8 TQ @ 200 C/C						
S6	125	8 TQ @ 200 C/C	8 TQ 0 200 C/C	8 <b>4 0</b> 200 C/C	8 TQ 0 200 C/C						
S7	150	10 क @ 125 C/C	10 क @ 125 C/C	8 TQ @ 200 C/C	8 TQ 0 200 C/C						
S8	125	8 TQ @ 200 C/C	8 TQ @ 200 C/C	8 TQ @ 200 C/C	8 TQ @ 200 C/C						
S3A	165	10 क @ 150 C/C	10 क @ 150 C/C	8 TQ @ 150 C/C	8 <b>4 0</b> 200 C/C						



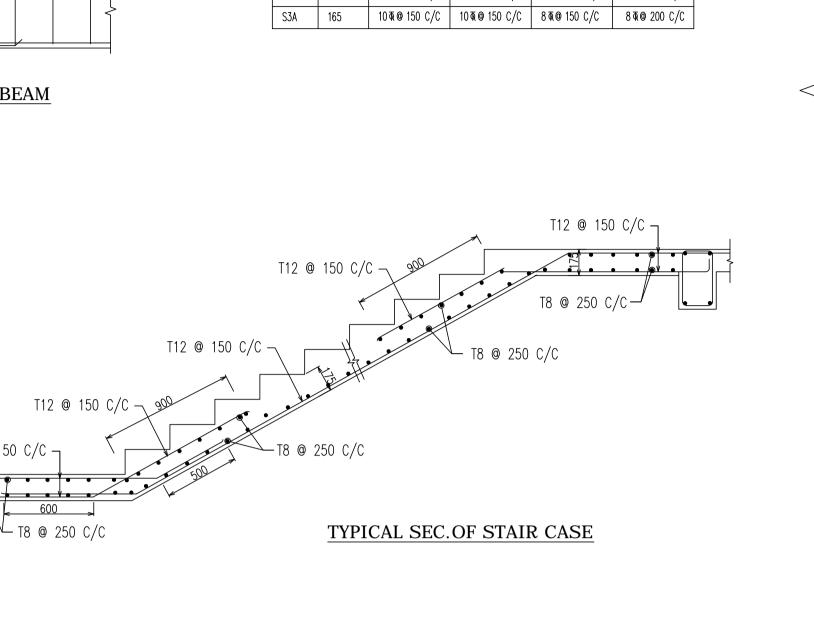

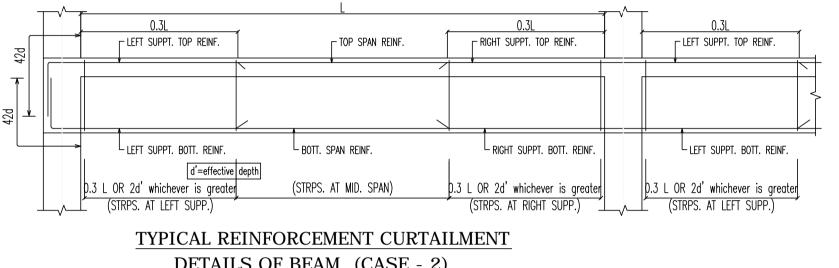

DETAILS OF BEAM (CASE - 2)

TYPICAL REINFORCEMENT CURTAILMENT

DETAILS OF BEAM (CASE - 1)

PROPERTY LINE B1 (230X500) U/S B3 (230X500) U/S GROUND FLOOR PLAN TOP OF GROUND FLOOR SLAB (STRL. LEV.) (+1200)

ВЕАМ	BEAI	M SIZE	REINF. AT LEFT S	UPP.	REINFT.	AT SPAN	REINF. AT RIGHT	SUPP.		STIRRUPS	
MKD.	WIDE	DEPTH	TOP	воттом	TOP	воттом	TOP	воттом	AT LEFT SUPPT.	AT SPAN	AT RIGHT SUP
B1 (U/S)	230	500	3−20 <b>ಥ</b> + 3−20 <b>ಥ</b>	3−20₹	2−20 ₹	3−20 क्	3−20 क् + 3−20 क	3−20₲	2L− 8Φ @ 100 C/C	2L- 8页 @ 200 C/C	2L− 85 © 100 C
B2	230	500	3−20 <b>ಥ</b> + 3−20 <b>ಥ</b>	3-20 \( \bar{a} + \) (2-20 \( \bar{a} + 1 - 16 \) (3)	2−20₵	3–20 ক + (2–20 ক +1–16 ক)	3−20 क् + 3−20 क्	3−20 क् + (2−20 क +1−16 क)	2L− 10♠ @ 100 C/C	2L− 10页 @ 200 C/C	2L-10 क @ 100 C
B3 (U/S)	230	500	3−20 <b>ಥ</b> + 3−20 <b>ಥ</b>	3−20 क्	2−20₵	3−20 ₹	2−20 ₹	2−20₹	2L− 8Φ @ 100 C/C	2L- 8页 @ 200 C/C	2L− 8क@ 100 C
B4	230	600	3−20 ₹	2–16 <b>অ</b> + 1–12 <b>অ</b>	2−20 ₹	2–16 অ+ 1–12 অ	2-20 <b>ፍ</b> + 2-16 <b>ፍ</b>	2-16 <b>ፍ</b> + 1-12 <b>ፍ</b>	2L− 8Φ @ 100 C/C	2L- 8页 @ 200 C/C	2L− 80 @ 100 C
B5	230	500	2−16 क्	2−16 क्	2−16 क्	2−16 क्	2−16 क्	2−16 क्	2L- 8▼ @ 100 C/C	2L- 80 @ 100 C/C	2L- 84 @ 100 C
В6	400	500	4-16 <b>ፍ</b> + 2-12 <b>ፍ</b>	4−16 ቒ	4−16 क्	4−16 क्	4–16 <b>፬</b> + 2–12 <b>፬</b>	4−16 क्	4L− 8Φ @ 100 C/C	4L- 80 @ 200 C/C	4L- 80 @ 100 C
В7	400	500	4–16 অ+ 2–12 অ	4−16 क्	4−16 क्	4−16 क्	4–16 জ+ 2–12 জ	4−16 क्	4L− 8क @ 100 C/C	4L− 8क @ 200 C/C	4L- 80 @ 100 C
B8	400	500	4–16 অ+ 2–12 অ	4−16 क्	4-16 क्	4-16 <b>Q</b>	4-16 <b>፬</b> + 2-12 <b>፬</b>	4–16 জ্ব	4L- 84 @ 100 C/C	4L− 8₲ @ 200 C/C	4L- 8क @ 100 C
В9	230	500	3−16 क्	2−16 क + 1−12 क	2−16 क्	2−16 क्+ 1−12 क्	3−16 क्	2-16 क्+ 1-12 क्	2L- 8₹ @ 100 C/C	2L- 8₲ @ 200 C/C	2L− 8♠ @ 200 (
B10	350	500	4–16 জ+ 2–12 জ	4−16 ₺	4−16 क्	4−16 ₲	4-16 <b>ፍ</b> + 4-16 <b>ፍ</b>	4−16 ₺	4L- 8क @ 100 C/C	4L− 8क® 200 C/C	4L- 84 @ 100 (
B11	350	500	4–16 জ+ 4–16 জ	4−16 ৳	4−16 क्	4−16 ₲	4−16 क्	4−16 ₹	4L− 8Φ @ 100 C/C	4L- 80 @ 200 C/C	4L- 8 🗖 @ 200 (
B12	900	500	(5-20\overline{4} +2-16\overline{4}) + 3-16\overline{4}	5−20 क्	5−20₵	5−20 क्	7−20 क् + 7−20 क	5−20₹	6L− 8Φ @ 100 C/C	6L- 84 @ 200 C/C	6L- 8 to @ 100 (
B13	900	500	7−20 क् + 7−20 क्	5−20 क्	5−20 ₹	(5-20क +2-16क) + 4-16 क	(5-20 क +2-25 क) +7-20 क	5−20₲	6L- 84 @ 100 C/C	6L- 84 @ 200 C/C	6L- 8 to @ 100 (
B14	900	500	(5-20 क +2-25क) +7-20 क	5−20 क्	5−20 क्	5−20 क्	5−20 क्	5−20 क्	6L− 8क @ 100 C/C	6L- 8 क @ 200 C/C	6L− 8क @ 100 (
B15	500	500	5−20 क्	5-16 <b>Q</b>	5−20₲	5-16 <b>a</b>	5-20 জ + 3-16 জ	5−16 क्	4L− 8क @ 100 C/C	4L− 8क @ 200 C/C	4L- 84 @ 100 (
B16	500	500	5-20 क + 3-16 क	5−16 ₹	5−20 क्	7−16 क्	7-20 क् + 7-20 क्	7−16 क्	4L− 8Φ @ 100 C/C	4L− 80 @ 175 C/C	4L- 84 @ 100 (
B17	500	500	7−20 <b>\</b> + 7−20 <b>\</b>	5−16 ₺	5−20 क्	5−16 क्	5−20 क्	5−16 क्	4L- 8 कि @ 100 C/C	4L- 8 क @ 100 C/C	4L- 8 क @ 100 (
B18	230	600	2−12 क्	2−16 ₲	2−12 ₹	2−16 ቒ	2−12 ቒ	2−16 क्	2L- 84 @ 150 C/C	2L- 84 @ 150 C/C	2L- 80 @ 150 (
B19	230	600	2−16 क्	2–16 <b>Q</b>	4−16 ₹	2−16 ₲	4–16 क्	2−16 क्	2L- 84 @ 100 C/C	2L- 84 @ 200 C/C	2L- 8  @ 200 (
B20	230	600	2-16 क+ 2-16 क	2−16 क्	2-16 क् + 2-16 क्	2−16 क्	2-16 \(\overline{\pi}\)+ 2-16 \(\overline{\pi}\)	2−16 क्	2L- 84 @ 100 C/C	2L- 84 @ 100 C/C	2L- 8 <b>a a</b> 100 (
B21	230	600	2−16 र् +	2−16 क्	2−16 रू+	2−16 क्	2−16 रू+	2−16 क्	2L- 85 @ 100 C/C	2L- 80 @ 100 C/C	2L- 80 @ 100 (
			2-16 क्+	2−16 ₲	2-16 <b>a</b> +	2−16 ₲	2-16 क्+	2−16 क्	2L- 80 @ 100 C/C	2L- 80 @ 100 C/C	2L- 80 @ 100 (
B22	230	600	2−16 क्		2−16 रू	6-20 <b>a</b> +	2-16 \( \bar{q} \) 6-20 \( \bar{q} \) +		4L- 8 T @ 100 C/C	4L- 8 ( 0 100 C/C	4L- 80 @ 100 (
B23	700	500	6−20 <b>₹</b> 6−20 <b>₹</b> +	6−20 ₹	6−20 क्	6−20 ₹	6−20 ₺	6−20₹	4L- 8 \$\overline{0} 0 0 0 0 0 0 0 0 0 0 0 0 0 0 0 0 0 0	4L- 80 @ 100 C/C	4L- 80 @ 100 (
B24	700	500	6−20 ₹ 3−16 ₹+	6–16 क्	6-20 ₹	6−16 क् 3−16 क्+	6−20 <b>₹</b> 2−16 <b>₹</b> +	6-16 क्	,	,	
B25	230	600	2-12 <b>Q</b>	3–16 ₹	2−16 ₲	2−16 रू	2−16 ቒ	2−16 Ф	2L- 84 @ 100 C/C	2L- 8 T @ 200 C/C	2L- 8 to @ 100 (
B26	650	500	7-20 <b>t</b>	7−20 <b>q</b> + 2−20 <b>q</b>	7−20 क्	7-20 <b>a</b> + 5-20 <b>a</b>	9−20 <b>q</b> + 7−25 <b>q</b>	7-20 क् + 2-20 क्	4L- 8क @ 100 C/C	4L- 80 @ 125 C/C	4L- 80 @ 100 (
B27	230	600	3–16 জ+ 2–16 জ	2−16 क+ 1−12 क	2−16 क्	2-16 क+ 1-12 क	2−16 क्	2−16 ₹	2L- 80 @ 100 C/C	2L- 80 @ 200 C/C	2L- 8 <b>( 0</b> 100 (
B28	700	500	7−20₹	7−20 क्	7−20₲	9-20 <b>\( \bar{\alpha}\)</b> + 9-20 <b>\( \bar{\alpha}\)</b>	9-20 <b>\(\bar{\bar{\bar{\bar{\bar{\bar{\bar{</b>	7−20 क्	4L- 80 @ 100 C/C	4L− 80 @ 200 C/C	4L- 8क @ 100 (
B29	700	500	9−20 क + 9−20 क	5−16 ₹	7−20₲	5−16 क्	7−20 <b>₹</b> + 2−16	5−16 क्	4L- 80 @ 100 C/C	4L− 80 @ 200 C/C	4L- 84 @ 100 (
B30	230	600	3−20 क + 2−20 क	3−16 ঢ়	2−20ቒ	3−16 क्	2−20₲	2−16 क्	2L- 80 0 100 C/C	2L− 8Φ @ 200 C/C	2L- 8 t @ 100 (

NIOI	ппо
NO.	11.51

1. ALL DIMENSIONS ARE IN MM. UNLESS OTHERWISE MENTIONED.

2. SUPER STRUCTURE: SUPER STRUCTURE SHALL BE OF 1ST CLASS BRICK IN 1:6 CEMENT MORTAR.

3. ALL GRADE OF CONCRETE M-30.

4. ALL MATERIALS SHALL CONFORM TO RELEVANT I.S CODES.

5. FOR STEEL GRADE Fe 500 AS PER I.S 1786-1979.

6. LAPS, SPLICES & BOND LENGTH SHOULD BE 50 D WHERE 'D' IS THE SMALLEST BAR DIA.

7. FOUNDATION & PLINTH: BRICKWORK IN FOUNDATION & PLINTH

SHALL BE OF 1ST CLASSBRICK IN 1:6 CEMENT MORTAR.

8. MINIMUM CLEAR COVER TO MAIN REINFORCEMENT IS AS FOLLOWS:

MEMBER TOP BOTTOM

a. STUB COLUMN

b. BAND BEAM.

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THE FOLLOWING ARCHITECTURAL DRAWINGS -

NO DATE REVISION

ISSUED FOR

OWNER

PROPOSED ADRESHA MALL AT SAKCHI, JAMSHEDPUR

TITLE

GROUND FLOOR G.A. AND SCHEDULE

ARCHITECTS

VINEET SINHA ARCHITECTS 1A, FIRST FLOOR, 'SMRITI', 8th AVENUE BISTUPUR, JAMSHEDPUR 831001 PH:2424998, FAX: 2424777

STRUCTURAL ENGINEERS

34, RAM MOHAN DUTTA ROAD


KOLKATA - 700020 .

PH. NO 2485-5448/5449,2475-7614(Tel.Fax) E-mail: spa\_cons@yahoo.co.in

DRAWN BY- CHECKED BY- DATE-KHOKAN PRITHWISH 24.08.18


SCALE: 1: 100,50,25 JOB NO. 2018 07 V.S. SPA/53-II ADRESHA MALL

DRG. NO. 2018 /07/V.S./SPA/53-II/ADRESHA MALL/ST-05/R0

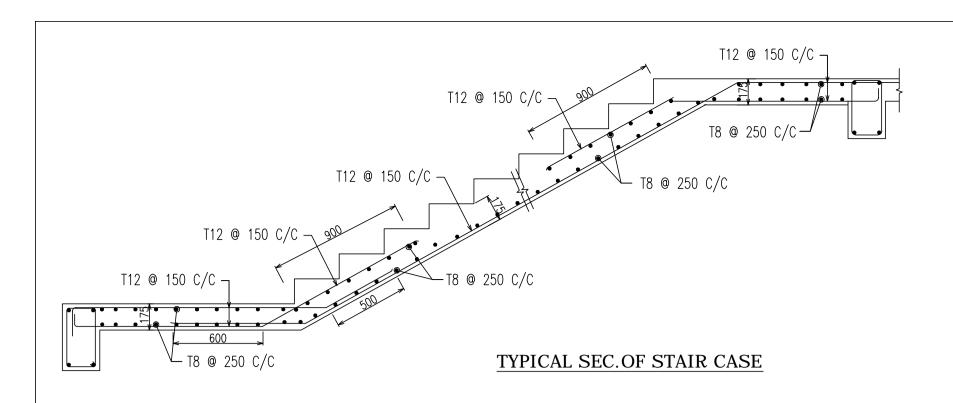


		CRETE -			DE11-15-	AT 00 ***			Ι	STIRRUPS	
BEAM MKD.		M SIZE		LEFT SUPP.	REINFT.		REINF. AT F		AT LEST OURDE	LT BIGUT GUIDET	
B1	WIDE 230	DEPTH 600	TOP 3-25 \(\bar{q}\) + 3-16 \(\bar{q}\)	3-25 ₹ + 2-25 ₹	TOP 3–25 <b></b> ₹	3−25 <b>T</b>	TOP 3-25♠+ 3-25♠	3-25 \bar{a} + 3-16 \bar{a}	AT LEFT SUPPT.  2L-10	AT SPAN 2L-10	AT RIGHT SUPPT
B2	230	600	3-25 <b>₹</b> + 3-16 <b>₹</b>	3−25 Ф	2−25₹	3-25₹	3-25 ₹ + 3-16 ₹	3−25♠	2L-10 ♠ @ 100 C/C	2L-10 <b>₹ ©</b> 150 C/C	2L-10 ♠ @ 100 C/0
В3	230	600	3-25 ₹ + 3-16 ₹	3-25 ₹ + 3-16 ₹	2−25♠	3−25 ₹	3-25 ₹ + 2-25 ₹	3-25 <b>₹</b> + 3-16 <b>₹</b>	2L-10 ₹ @ 100 C/C	2L-10 ₹ @ 100 C/C	2L-10 क @ 100 C/0
B4	230	600	3–25₹	3–16 ₮	2−25₹	3-16 ℚ+ 2-12 ℚ	2−25₵	3–16 ₹	2L− 8₲ @ 100 C/C	2L- 80 @ 150 C/C	2L- 8₲ @ 100 C/
B5	230	600	3-16 <b>₹</b> + 2-16 <b>₹</b>	3−16 र्ष+ 2−12 र्ष	2−16 रू	3–16 ₹	3-16 क्+ 3-16 क्	3−16 रू	2L- 84 @ 100 C/C	2L- 84 @ 150 C/C	2L- 84 @ 100 C/
B6	230	600	2−16 रू	2−16 ₹	2−16 रू	2−16 ₵	3−16 क्	2−16 रू	2L− 8Φ @ 100 C/C	2L- 84 @ 150 C/C	2L- 84 @ 100 C/
B7	250	600	3-16 <b>₹</b> + 3-16 <b>₹</b>	3−16 रू	2−16 Ф	3–16 ₺	3-16 क+ 2-12 क	3−16 ₹	2L− 8♠ @ 100 C/C	2L- 84 @ 150 C/C	2L- 84 @ 100 C/
B8	250	600	3-16 <b>₹</b> + 2-12 <b>₹</b>	3−16 ৢ	2−16 ₹	3−16 ₹	3–16 <b>\(\bar{\Pi}\)</b> + 2–16 <b>\(\bar{\Pi}\)</b>	3−16 ₹	2L- 8₹ @ 100 C/C	2L- 8₲ @ 150 C/C	2L− 8♠ № 100 C/
B9	250	600	3-16 <b>₹</b> + 2-16 <b>₹</b>	3−16 ₹	2−16 ₹	3−16 ᅑ	3−16 \(\overline{A}\) + 3−16 \(\overline{A}\)	3−16 ₹	2L- 8页 @ 100 C/C	2L- 8页 @ 150 C/C	2L- 8 Q 100 C/
B10	230	600	3−16 रू	2−16 रू	2−16 रू	3−16 ₺	3−16 क्	2−16 रू	2L- 8页 @ 100 C/C	2L− 84 @ 150 C/C	2L- 8 Q 100 C/
B11	350	600	4-16 ₹ + 3-16 ₹	4–16 ₹	4−16 ₺	4−16 <b>\</b> + 2−16 <b>\</b>	5-16 <b>\(\bar{\Pi}\)</b> + 4-20 <b>\(\bar{\Pi}\)</b>	4–16 জ+ 4–16 জ	4L- 80 @ 100 C/C	4L- 80 @ 150 C/C	4L− 80 @ 100 C/
B12	350	600	5-16 क+ 4-20 क	4−16 क	5−16 ₹	4−16 रू	5–16 ₹	4−16 रू	4L- 8♠ @ 100 C/C	4L- 8 क @ 150 C/C	4L- 80 @ 150 C/
B13	800	600	8-16 क्+ 7-16 क्	8−16 क	8−16 ₹	8−16 रू	8−16 <b>\( \alpha\)</b> + 6−20 <b>\( \alpha\)</b>	8−16 ₹	6L- 8页 @ 100 C/C	6L- 8页 @ 150 C/C	6L- 84 @ 100 C/
B14	800	600	8-16 <b>Φ</b> + 6-20 <b>Φ</b>	8−16 क्	8−16 Φ	8−16 क + 4−16 क	8-16 <b>₹</b> + 5-25 <b>₹</b>	8−16 रू	6L- 84 @ 100 C/C	6L- 8页 @ 150 C/C	6L- 84 @ 100 C/0
B15	800	600	8−16 क्+ 5−25 क्	8−16 क्	8−16 क्	8−16 क्	8−16 Φ	8−16 Ф	6L- 8♠ @ 100 C/C	6L− 8₹ @ 150 C/C	6L- 84 @ 100 C/
B16	230	600	2−16 रू	2−16 क्	2−16 रू	2−16 रू	3-16 ₹ + 3-20 ₹	2−16 Ф	2L- 8页 @ 200 C/C	2L- 8 क @ 150 C/C	2L- 80 @ 150 C/
B17	230	600	3-16 ♠+ 3-20♠	2−16 रू	2−16 रू	3−16 <b>\</b> + 2−16 <b>\</b>	3–16 <b>₹</b> + 2–16 <b>₹</b>	3−16 क्	2L- 8 Q 0 100 C/C	2L- 84 @ 150 C/C	2L- 84 @ 100 C/
B18	230	600	3−16 र् + 2−16 र (	3−16 क्	2−16 ₹	2−16 ₵	2−16 ₹	2−16 क्	2L- 8 Q @ 150 C/C	2L- 8 <b>Q</b> 9 150 C/C	2L- 8页 @ 200 C/
B19	350	600	4−16 क्	4−16 रू	4-16 <b>ፍ</b> + 2-16 <b>ፍ</b>	4−16 क्	4−16 र् + 3−25 र	4−16 क्	4L- 80 0 100 C/C	4L- 8₲ @ 100 C/C	4L- 80 0 100 C/0


GRADE	OF CON	RFTF _	M30								
		M SIZE		EET CUIDD	DEINET A	AT CDAN	DEINE AT D	IOUT OUDD		CTIDDUDE	
BEAM MKD.	WIDE	DEPTH	REINF. AT L	BOTTOM	REINFT. A	BOTTOM	REINF. AT R	BOTTOM	AT LEFT SUPPT.	STIRRUPS AT SPAN	AT RIGHT SUPPT
B20	350	600	4-16 <b>₹</b> + 3-25 <b>₹</b>	4−16 ₺	4−16 ₹	4−16 ₺	4-16 ♠ + 3-16 ♠	4−16 <b>T</b>	4L- 8 \$ @ 100 C/C	4L- 8 \$ @ 150 C/C	4L- 80 @ 100 C/C
B21	230	600	3−25 क + 2−25 क	2−25 <b>₹</b> 1−12 <b>₹</b>	2−25₹	2−25₹	3−25₵	3−25 <b>\</b> + 3−16 <b>\</b>	2L-10 क @ 100 C/C	2L-10 ₲ @ 100 C/C	2L-10 क @ 100 C/C
B22	230	600	3-25♠+ 2-16♠	3-25♠+ 3-16♠	2−25₹	2−25₹	2−25₵	3−25 <b>፬</b> + 2−16 <b>፬</b>	2L-10 <b>₹ ©</b> 100 C/C	2L-10▼@ 100 C/C	2L-10 ₹ @ 100 C/C
B23	230	600	2−16 ₹	2−16 ₹	2−16 ₹	2−16 रू	2−16 रू	2−16 ₹	2L− 84 @ 150 C/C	2L- 84 @ 150 C/C	2L− 8¶ @ 150 C/C
B24	230	600	3−16 <b>\</b> + 2−12 <b>\</b>	2−16 ₹	3–16 ₹	2−16 रू	3–16 ₹	2−16 रू	2L- 84 @ 150 C/C	2L- 8 T @ 150 C/C	2L- 84 @ 150 C/C
B25	230	600	3−20 ₺	3−20₹	3−20₹	3−20 ₺	3−20 ₺	3−20₵	2L- 84 @ 100 C/C	2L− 84 @ 100 C/C	2L- 84 @ 100 C/C
B26	230	600	3-20 ₹ + 2-20 ₹	3-20 <b>₹</b> + 2-20 <b>₹</b>	2−20₵	2−20 क्	3−20 क्	2−20₵	2L-10 ♠ @ 100 C/C	2L-10 ♠ @ 100 C/C	2L-10 ₹ @ 100 C/C
B27	230	600	3−20 ₺	2-20₲	2−20₹	2−20₵	2-20₲	2−20₵	2L-10 क @ 100 C/C	2L-10 क @ 100 C/C	2L-10 क @ 100 C/C
B28	800	600	6−16 रू	8−16 रू	6−16 ₹	8−16 रू	10-16 क् + 9-25 क्	8−16 रू	6L- 84 @ 100 C/C	6L- 8页 @ 100 C/C	6L- 84 @ 100 C/C
B29	800	600	10−16 क् + 9−25 क्	8−16 क्	8−16 ₹	8–16 ক্	8–16 ক্	8−16 क्	6L- 84 @ 100 C/C	6L- 80 @ 150 C/C	6L- 84 @ 100 C/C
B30	230	600	3-16 <b>\</b> + 2-20 <b>\</b>	2−20₵	3–16 ₹	3−20 ₺	3−16 क्+ 2−16 क्	3−20 <b>₹</b> + 3−16 <b>₹</b>	2L-10 क @ 100 C/C	2L-10 ₹ @ 150 C/C	2L-10 क @ 100 C/C
B31	500	600	4−25 ₹	6−16 <b>\(\bar{\alpha}\)</b> + 4−20 <b>\(\bar{\alpha}\)</b>	4−25₹	6−16 र्ष + 6−20 ⁄ष	6−25 <b>₹</b> + 4−25 <b>₹</b>	6−16 <b>Φ</b> + 4−20 <b>Φ</b>	4L- 80 @ 150 C/C	4L- 80 @ 100 C/C	4L- 80 0 100 C/C
B32	230	600	3−16 क+ 3−20 क	3−16 क्	2−16 ₹	3−16 रू	2−16 रू	3−16 क्	2L-10 ₱ @ 100 C/C	2L-10 ₹ @ 150 C/C	2L-10 क @ 100 C/C
B33	800	600	8−16 रू	8−16 क्	10−16 क् + 5−25 क्	8−16 रू	12−16 रू + 10−25 रू	8-16 অ+ 4-16 অ	6L- 84 @ 100 C/C	6L- 8 T @ 100 C/C	6L- 84 @ 100 C/C
B34	800	600	12−16 क् + 10−25 क्	8−16 <b>Φ</b> + 4−16 <b>Φ</b>	8−16 ₹	8-16 क्+ 4-16 क्	8−16 <b>Φ</b> + 6−20 <b>Φ</b>	8−16 <b>Φ</b> + 4−16 <b>Φ</b>	6L- 84 @ 100 C/C	6L- 80 @ 150 C/C	6L- 84 @ 100 C/C
B35	230	600	3-25 ₹ + 3-16 ₹	2−25Ф	2−25₹	2−25₵	2−25₹	2−25₹	2L-10 क @ 100 C/C	2L-10 ₲ @ 150 C/C	2L-10 क @ 100 C/C
B36	350	600	4−25₹	4−16 रू	4−25 वि	4−16 रू	4-25 ₹ + 3-25 ₹	4−16 <b>\</b> + 2−20 <b>\</b>	4L-10页@ 100 C/C	4L-10 ₹ @ 100 C/C	4L-10 क @ 100 C/C
B37	350	600	4−25 क + 3−25 क	4−16 <b>\</b> + 2−20 <b>\</b>	4−25₹	4−16 <b>ℚ</b> + 2−20 <b>ℚ</b>	4−25Ф	4−16 <b>\</b> + 6−20 <b>\</b>	4L-10页@ 100 C/C	4L−10 ₹ @ 150 C/C	4L-10酉@ 100 C/C
B38	350	600	4−25 क्	4−16 ₹	4−25₹	4−16 ₹	4−25₵	4−16 ₹	4L- 84 @ 100 C/C	4L- 84 @ 150 C/C	4L- 8 क @ 100 C/C

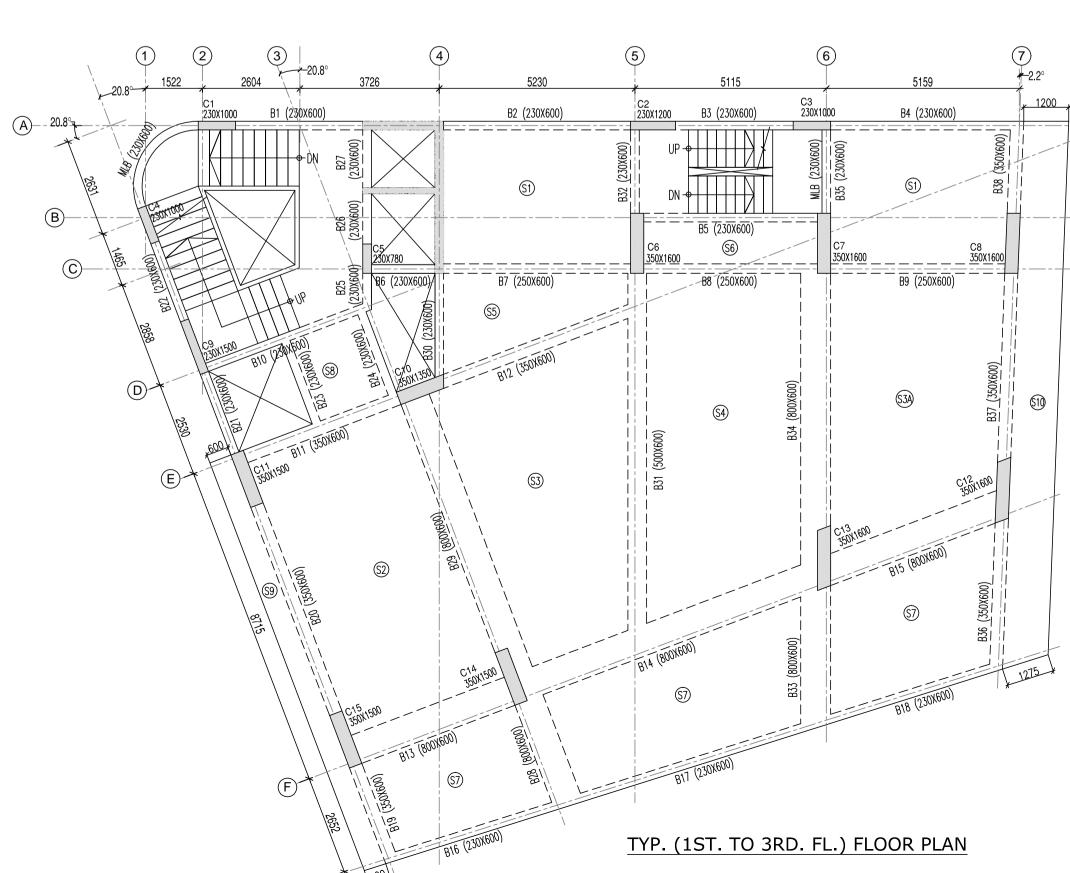


GRADE	OF CONCR	ETE - M30			
SLAB	DEDTIL	REINF. AT SHORT	ER DIRECTION	REINF. AT LONG	ER DIRECTION
MKD.	DEPTH	SUPPT. (TOP)	SPAN (BOTT.)	SUPPT. (TOP)	SPAN (BOTT.)
S1	150	8 TQ @ 150 C/C	8 TQ 0 150 C/C	8 TQ 0 200 C/C	8 to @ 200 C/C
S2	165	10 to @ 125 C/C	10 t @ 150 C/C	8 TA @ 150 C/C	8 क @ 200 C/C
S3	200	10 क @ 125 C/C	10 to @ 150 C/C	10 t @ 200 C/C	10 क @ 200 C/0
S4	165	10 क @ 150 C/C	10 t @ 150 C/C	8 TQ @ 200 C/C	8 Ta @ 200 C/0
S5	150	8 क @ 200 C/C	8 <b>क ©</b> 200 C/C	8 TQ @ 200 C/C	8 क @ 200 C/C
S6	125	8 क @ 200 C/C	8 T @ 200 C/C	8 TQ @ 200 C/C	8 क @ 200 C/C
S7	150	10 क @ 125 C/C	10 क @ 125 C/C	8 T @ 200 C/C	8 क @ 200 C/C
S8	125	8 <b>क @</b> 200 C/C	8 क @ 200 C/C	8 TQ 0 200 C/C	8 क @ 200 C/C
S9	165	10 <b>₹ @</b> 150 C/C	10 क @ 150 C/C	8 <b>T</b> @ 150 C/C	8 TQ 200 C/0
S10	150	10 क @ 150 C/C	8 T @ 200 C/C	8 TQ @ 200 C/C	8 TQ @ 200 C/0

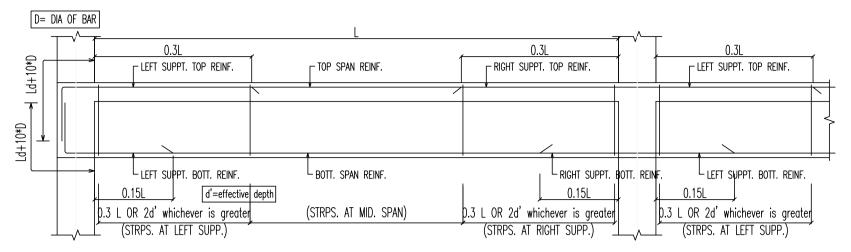


### TYPICAL REINFORCEMENT CURTAILMENT DETAILS OF BEAM (CASE - 1)

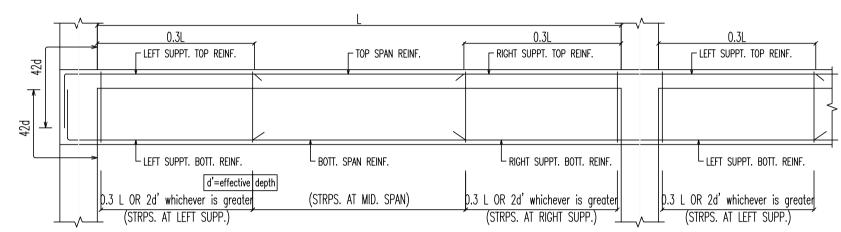

### TYPICAL REINFORCEMENT CURTAILMENT DETAILS OF BEAM (CASE - 2)

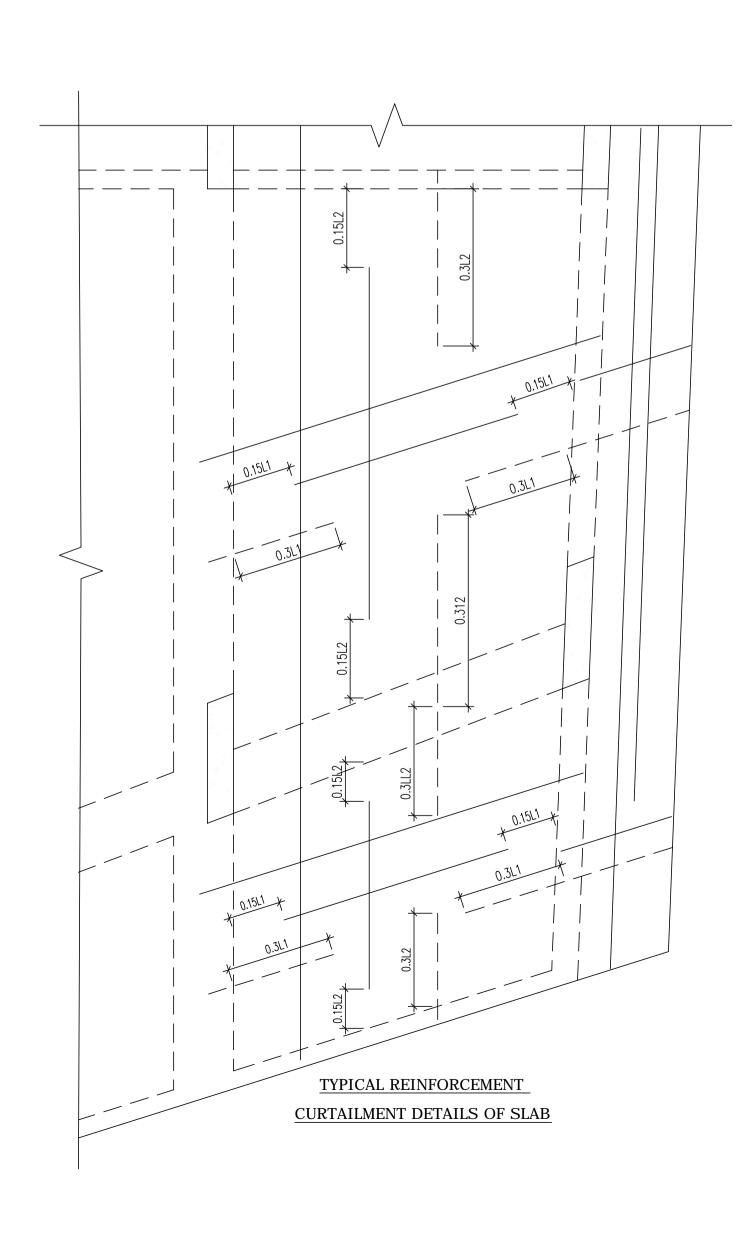

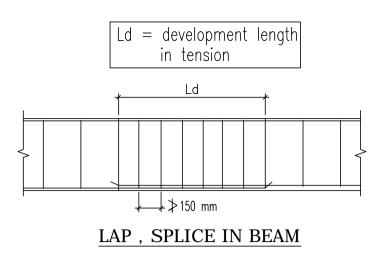

NOTES:-

1. ALL DIMENSIONS ARE IN MM. UNLESS OTHERWISE MENTIONED.

2. SUPER STRUCTURE: SUPER STRUCTURE SHALL BE OF 1ST CLASS BRICK IN 1:6 CEMENT MORTAR.

3. ALL GRADE OF CONCRETE M-30.

4. ALL MATERIALS SHALL CONFORM TO RELEVANT I.S CODES.

5. FOR STEEL GRADE Fe 500 AS PER I.S 1786-1979.

6. LAPS, SPLICES & BOND LENGTH SHOULD BE 50 D WHERE 'D' IS THE SMALLEST BAR DIA.

7. FOUNDATION & PLINTH: BRICKWORK IN FOUNDATION & PLINTH

SHALL BE OF 1ST CLASSBRICK IN 1:6 CEMENT MORTAR.

8. MINIMUM CLEAR COVER TO MAIN REINFORCEMENT IS AS FOLLOWS:

MEMBER TOP a. STUB COLUMN

b. BAND BEAM.

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REVISION	NO	DATE
ISSUED FOR		
OWNER		

PROPOSED ADRESHA MALL AT SAKCHI, JAMSHEDPUR

TYP. FLOOR (1ST. TO 3RD. FL.) G.A. AND SCHEDULE

ARCHITECTS

VINEET SINHA ARCHITECTS 1A, FIRST FLOOR, 'SMRITI', 8th AVENUE BISTUPUR, JAMSHEDPUR 831001 PH:2424998, FAX: 2424777

STRUCTURAL ENGINEERS

34, RAM MOHAN DUTTA ROAD KOLKATA – 700020 . PH. NO 2485-5448/5449,2475-7614(Tel.Fax) E-mail: spa\_cons@yahoo.co.in DRAWN BY- CHECKED BY- DATE-

SCALE: KHOKAN PRITHWISH 24.08.18 1: 100,50,25 JOB NO. 2018 07 V.S. SPA/53-II ADRESHA MALL DRG. NO. 2018 /07/V.S./SPA/53-II/ADRESHA MALL/ST-06/R0