




NOTE:
 1. FOUNDATION & R.C.C. AS PER STRUCTURAL ENGG. SPECIFICATION
 2. ALL EXISTING STRUCTURE TO BE DEMOLISHED
 3. ALL DIMENSIONS IN Mtrs.
 4. DRAWING NOT TO BE MEASURED.

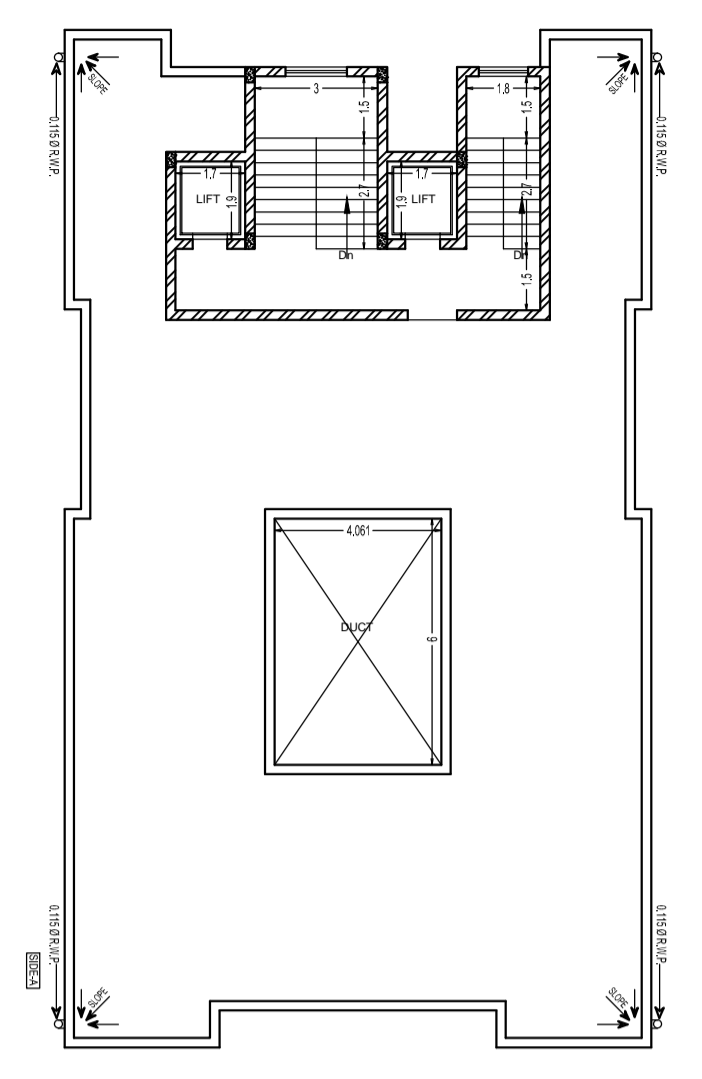


TERRACE FLOOR PLAN
SCALE: 1:100

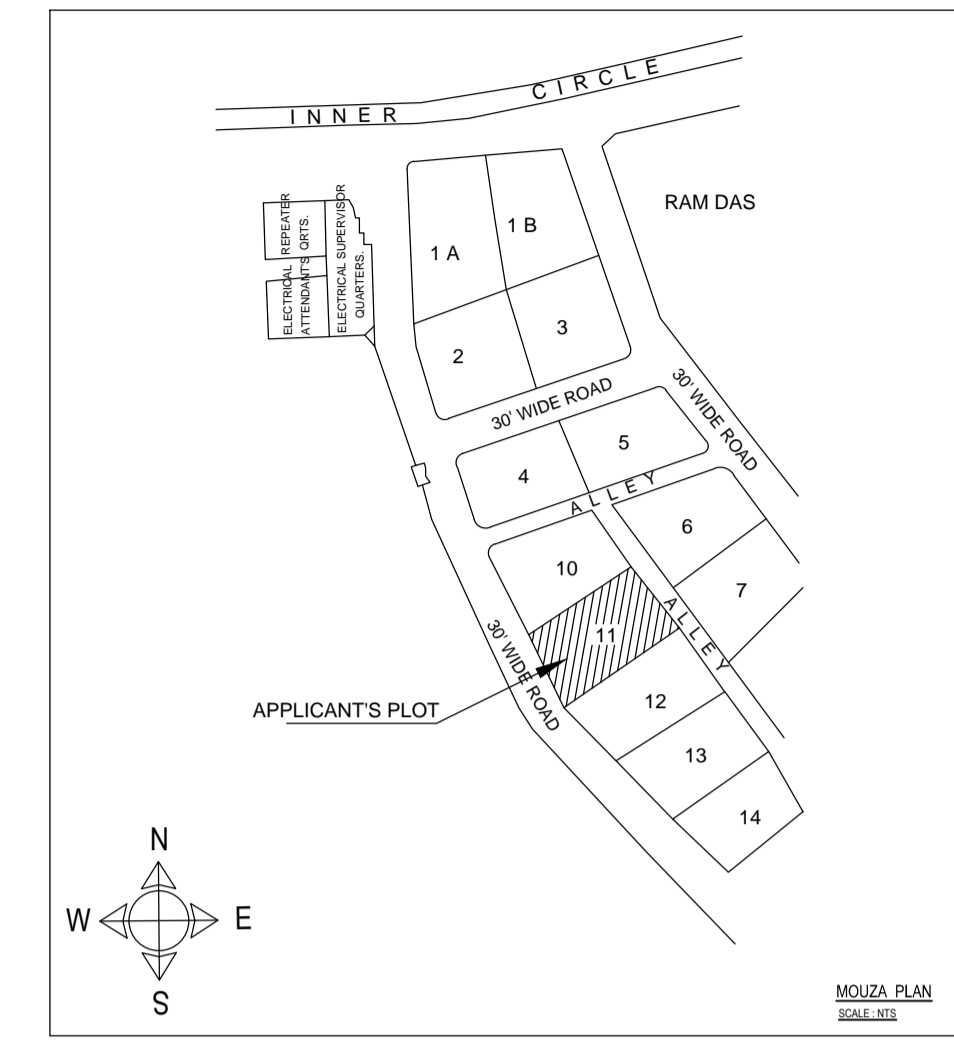

MOUZA PLAN
SCALE: 1:1000

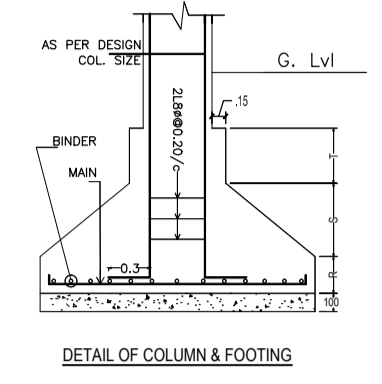


DETAIL OF COLUMN & FOOTING

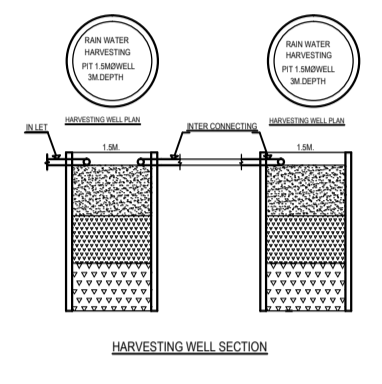


HARVESTING WELL SECTION

FLOORS	AREA WITHIN P.L. LINE	AREA IN PROJECTION PERMISSIBLE WITHIN SET BACK	AREA IN PROJECTION BEYOND P.L. WITHIN SETBACK	TOTAL COVERED AREA	AREA DEDUCTION								NET AREA FOR FAR	OCCUPANCY OR USE PROPOSED	REMARK
					LIFT WELL	50% BALCONY	STAR VOID	DUCT	FIRE STAIR	PARKING IF PERM.	OTHER IF PERM.	TOTAL DEDUCTION			
BASEMENT	321.50	NIL	NIL	321.50	NIL	NIL	NIL	NIL	NIL	287.59	NIL	287.59	33.91	PARKING	
GR. FLOOR	317.62	NIL	NIL	317.62	6.46	NIL	NIL	24.36	10.26	NIL	NIL	41.08	276.54	RESIDENTIAL	
1ST FLOOR	317.62	NIL	NIL	317.62	6.46	NIL	NIL	24.36	10.26	NIL	NIL	41.08	276.54	RESIDENTIAL	
2ND FLOOR	317.62	NIL	11.56	329.18	6.46	5.78	NIL	24.36	10.26	NIL	NIL	46.86	282.32	RESIDENTIAL	
3RD FLOOR	317.62	NIL	11.56	329.18	6.46	5.78	NIL	24.36	10.26	NIL	NIL	46.86	282.32	RESIDENTIAL	
4TH FLOOR	317.62	NIL	11.56	329.18	6.46	5.78	NIL	24.36	10.26	NIL	NIL	46.86	282.32	RESIDENTIAL	
TOTAL	1908.60	NIL	34.68	1943.28	32.30	17.34	NIL	121.80	51.30	287.59	NIL	510.33	1433.95		

DOORS, WINDOWS AND VENTILATORS DETAILS						
S.No	TYPE	LENGTH	HEIGHT	SILL LEV.	LINTEL LEV.	DESCRIPTIN
1	D	1.20m	2.10m	0.0m	2.1m	FULLY GLASSED DOOR
2	D1	0.90m	2.10m	0.0m	2.1m	FULLY GLASSED DOOR
3	D2	0.75m	2.10m	0.0m	2.1m	FULLY GLASSED DOOR
4	W8	2.40m	1.20m	0.90m	2.1m	FULLY GLASSED STEEL WINDOW
5	W5	1.50m	1.20m	0.90m	2.1m	FULLY GLASSED STEEL WINDOW
6	W4	1.20m	1.20m	0.90m	2.1m	FULLY GLASSED STEEL WINDOW
7	W3	0.90m	1.20m	0.90m	2.1m	FULLY GLASSED STEEL WINDOW
8	V	0.60m	0.60m	1.50m	2.1m	FULLY GLASSED VENTILATION

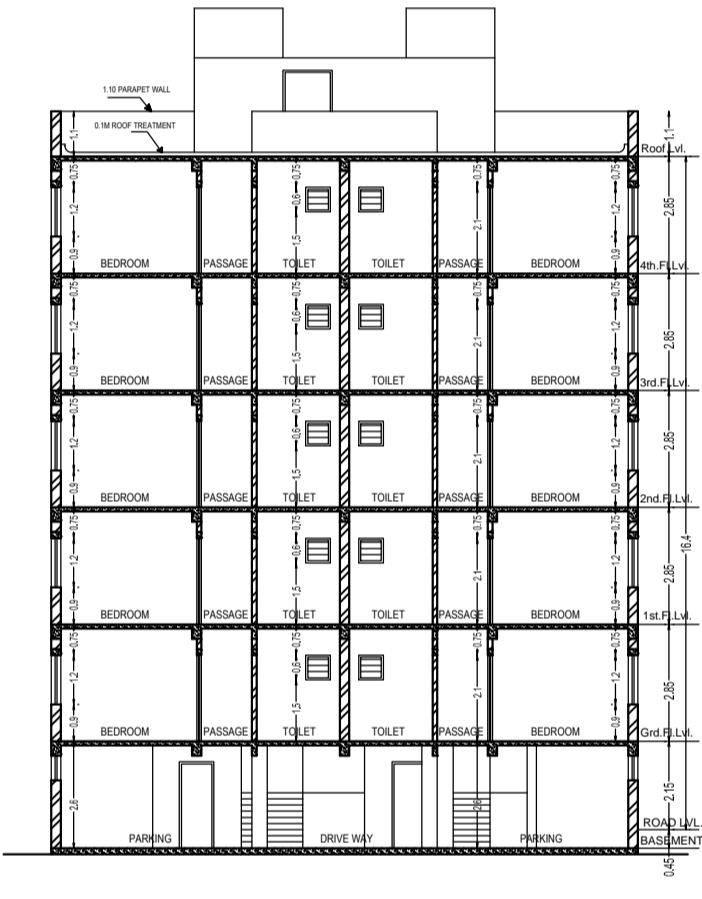

SECTION X-X
SCALE: 1:100

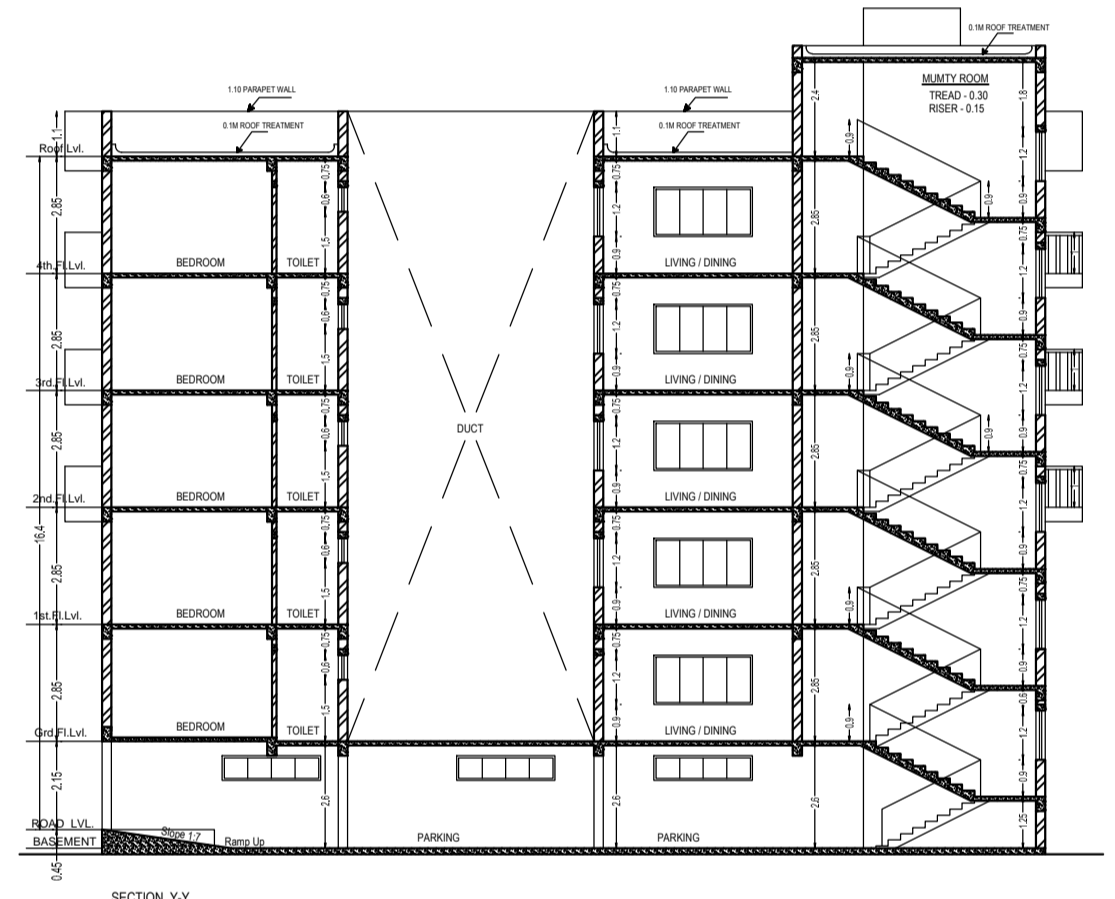

SECTION Y-Y
SCALE: 1:100



FRONT ELEVATION
SCALE: 1:100




SIDE-A ELEVATION
SCALE: 1:100

OWNER / POAH


Signature of Applicant:-

- GENERAL SPECIFICATION :-**
- FOUNDATION : PLAIN CEMENT CONCRETE AS PER DESIGN
 - : R.C.C. COLUMN FOOTING & COLUMN AS PER STRUCTURAL DESIGN.
 - SUPER STRUCTRE : R.C.C. COLUMN & BEAM AS PER STR. DESIGN
 - : 0.23M THK. EXT. WALL & 0.125M THK. PARTITION WALL IN CEMENT MORTAR
 - : R.C.C. ROOF SLAB AS PER STRUCTURAL DESIGN.
 - FLOOR : CERAMIC TILES FLOOR AND DADO.
 - INTERNAL FINISH : CEMENT PLASTER WITH P.O.P & O.B.D.
 - SANITARY : VITROUS CHAINA CLAY SANITARY WARE. G.I. PIPE WATER SUPPLY.
 - : P.V.C PIPE FOR SEWAGE DISPOSAL.
 - DOORS & WINDOW : AS PER SCHEDULE.
 - ELECTRICAL : COPPER WIRE WITH P.V.C. CONDUIT.


PROPOSED RESIDENTIAL BUILDING PLAN OF SRI PRAFUL CHANDRA DAYALJI & OTHERS
 HOLDING NO. 11,
 CONTRACTORS AREA.
 TOWN - JAMSHEDPUR,
 DIST.- EAST SINGHBHUM, JHARKHAND.

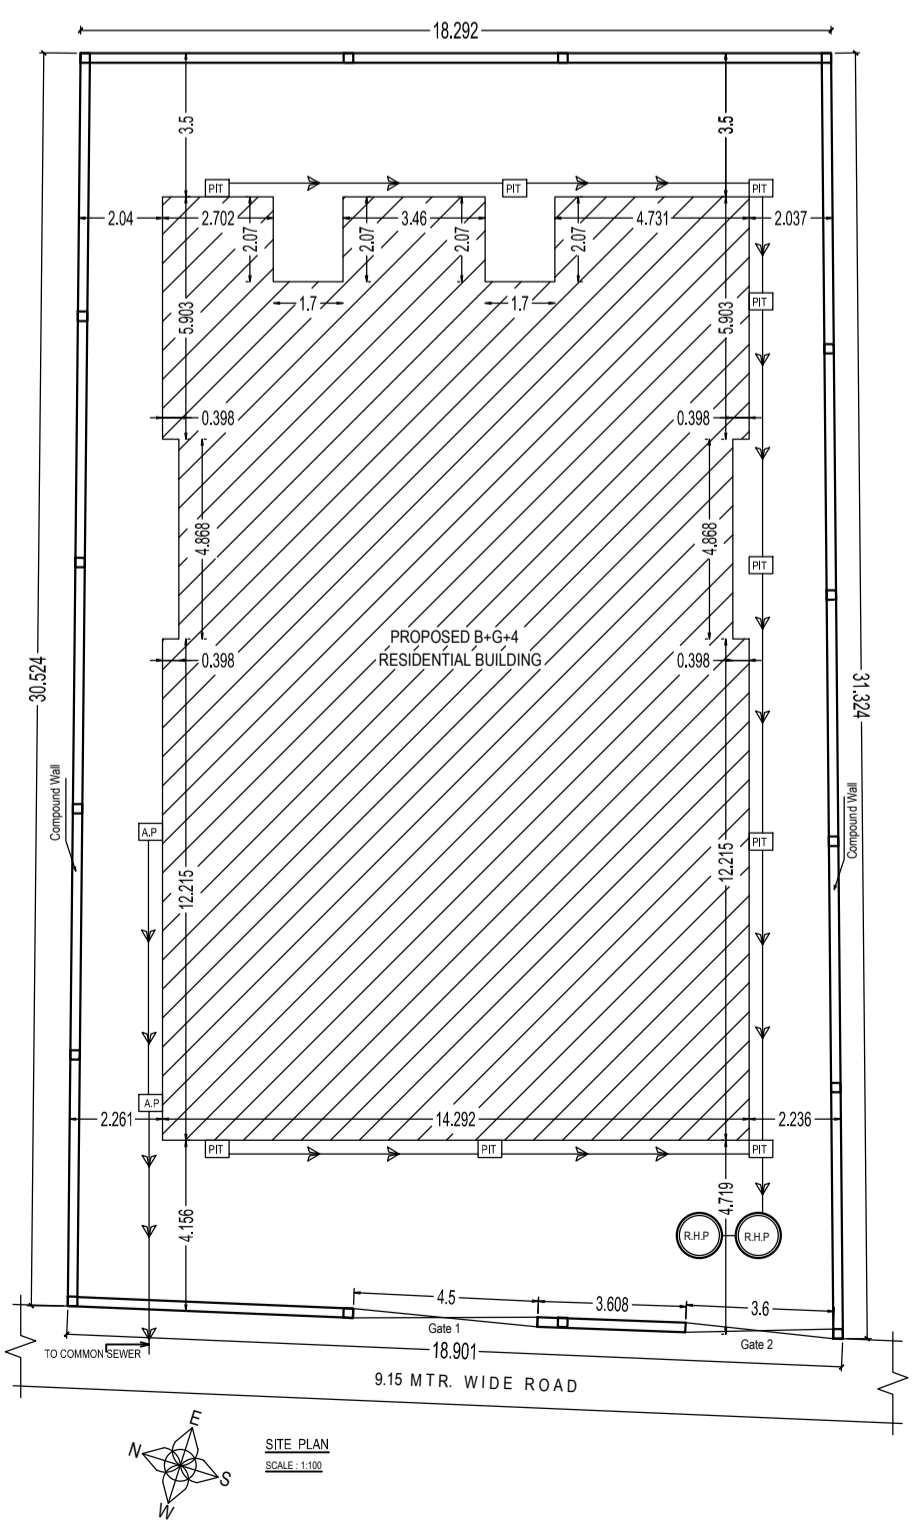


SITE PLAN
SCALE: 1:100

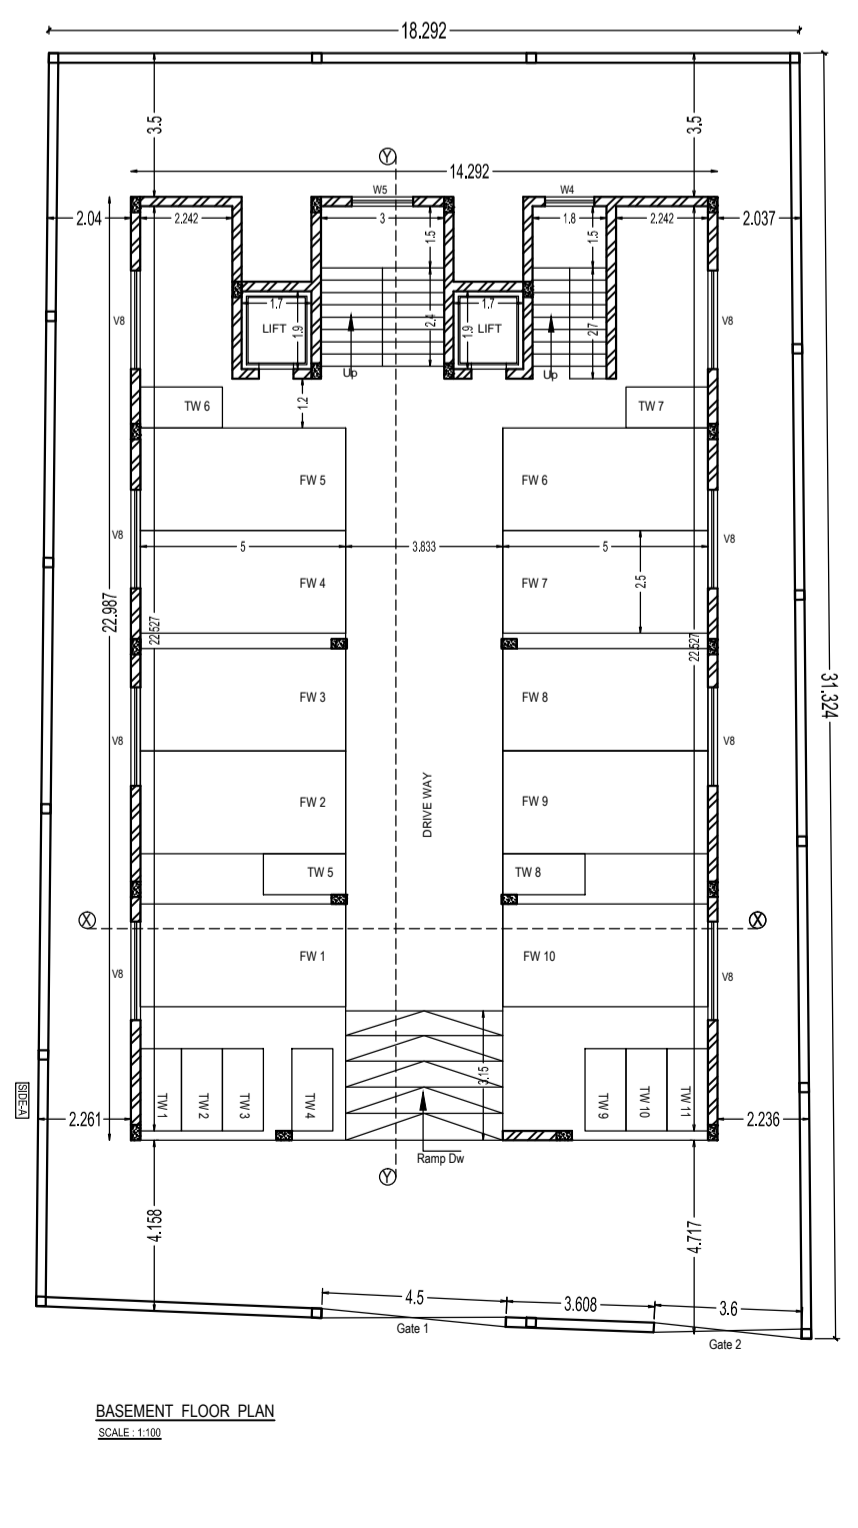


BASEMENT FLOOR PLAN
SCALE: 1:100

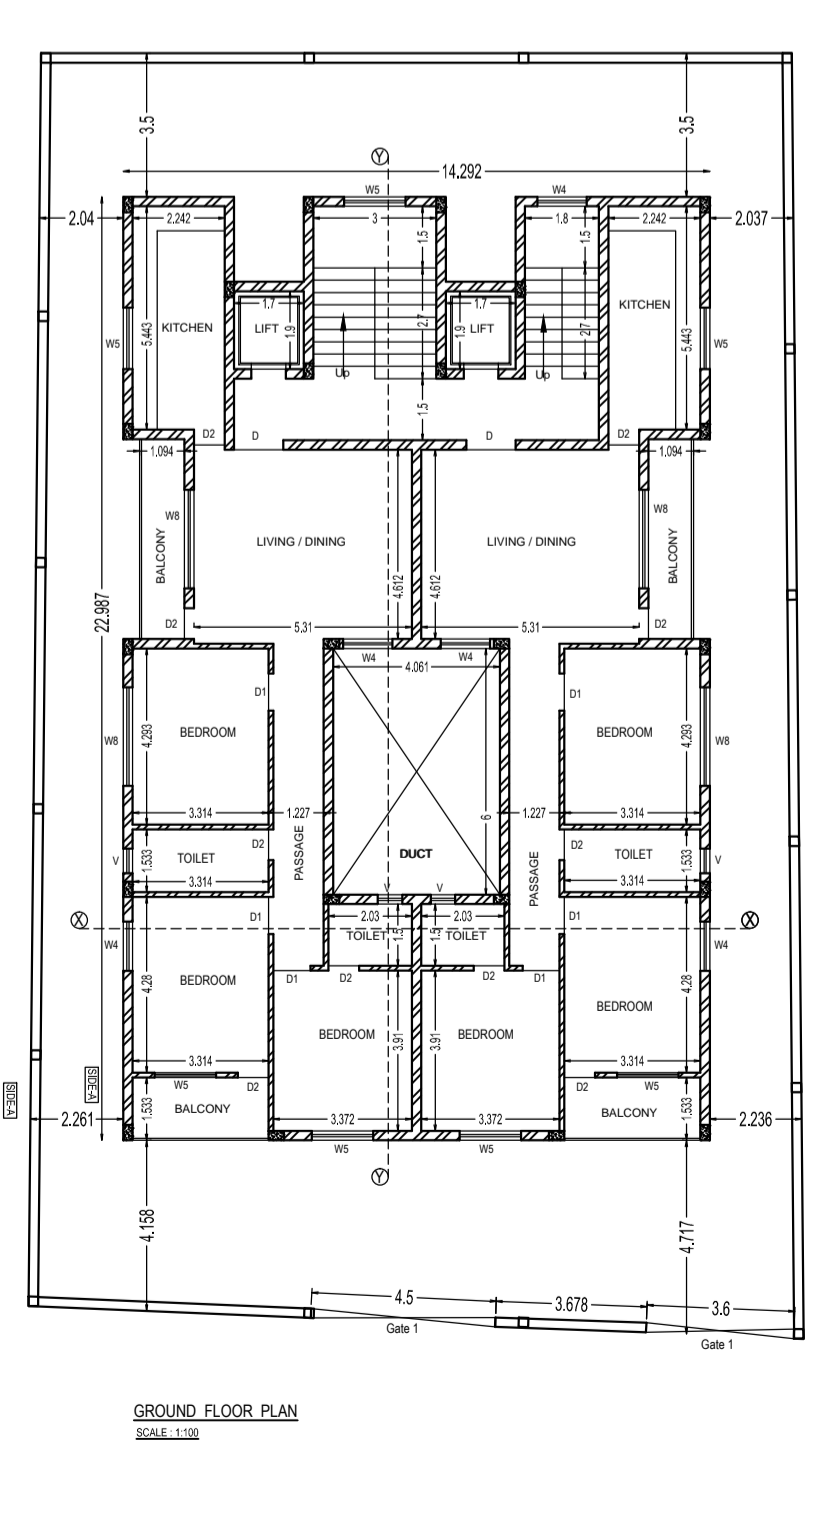

GROUND FLOOR PLAN
SCALE: 1:100

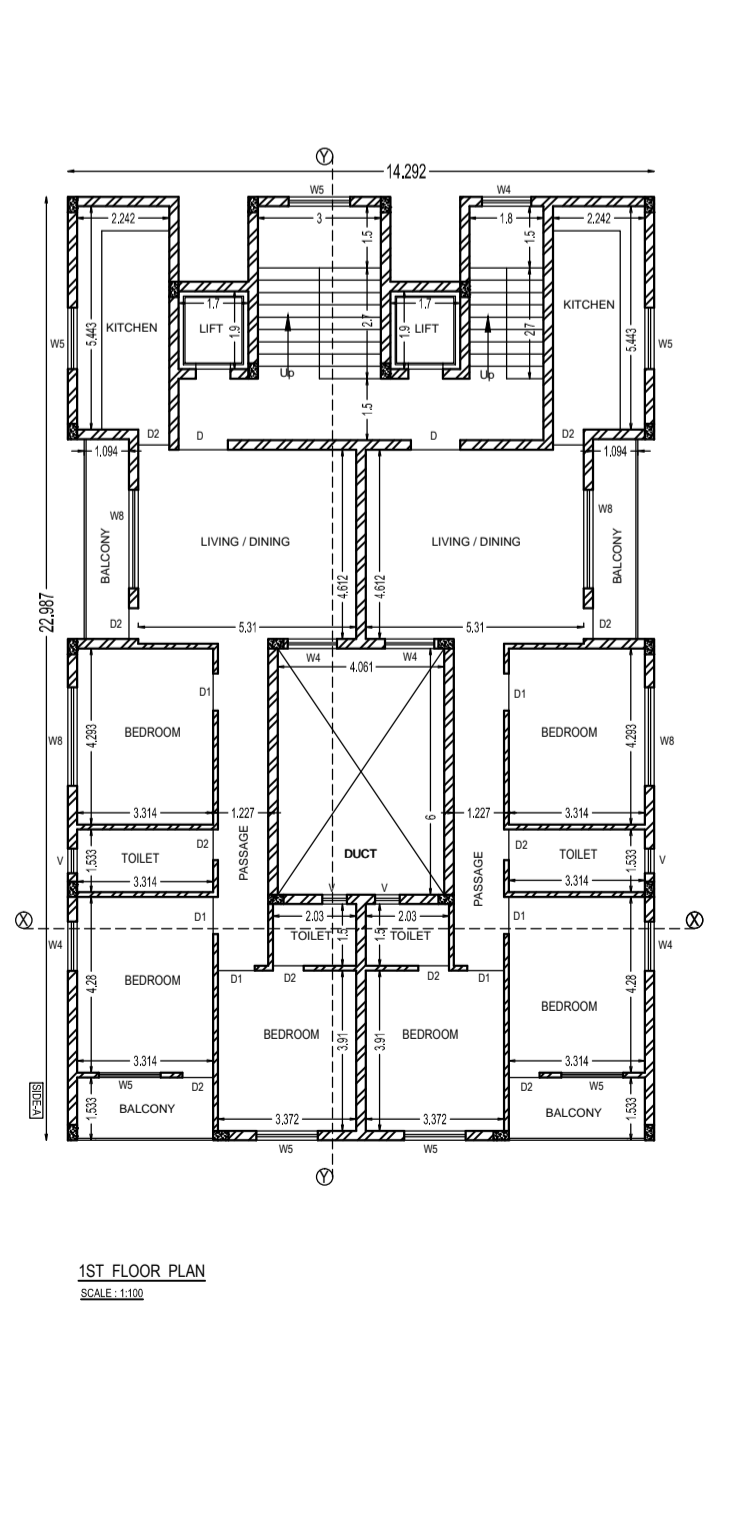

1ST FLOOR PLAN
SCALE: 1:100

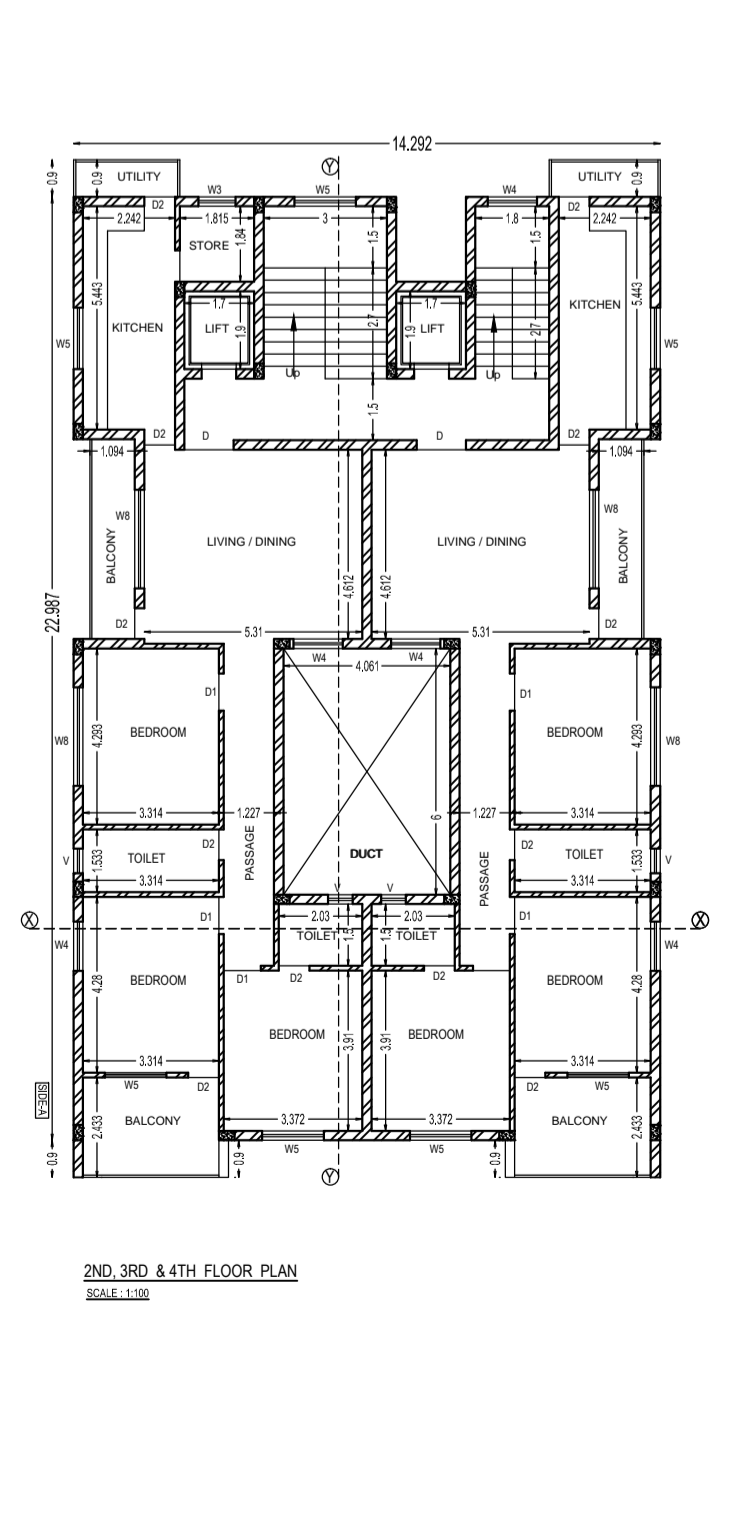

2ND, 3RD & 4TH FLOOR PLAN
SCALE: 1:100

SHEET No- 01 / 01

L.K. SUMAN
 Office : 1, Second Floor
 Basant Talkies Complex,
 Sakchi, Jamshedpur

Reg No- JNAC/ENG/0006/2016