

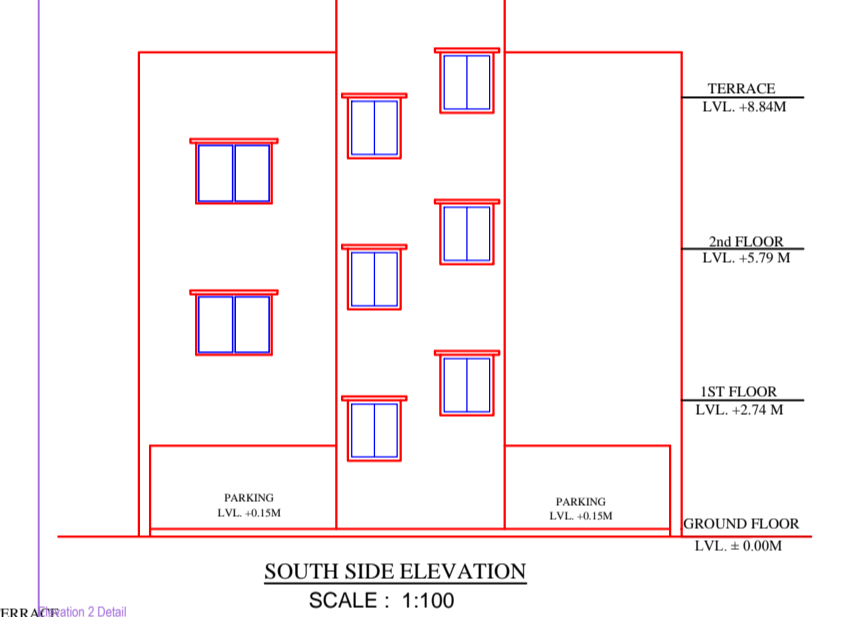
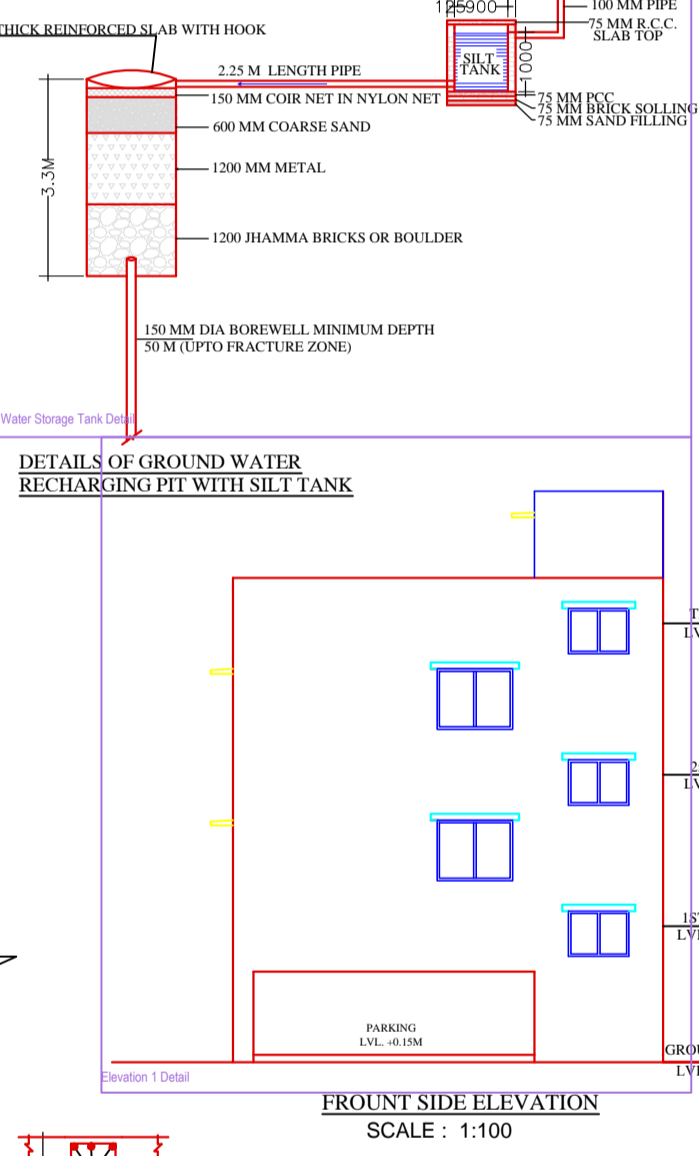
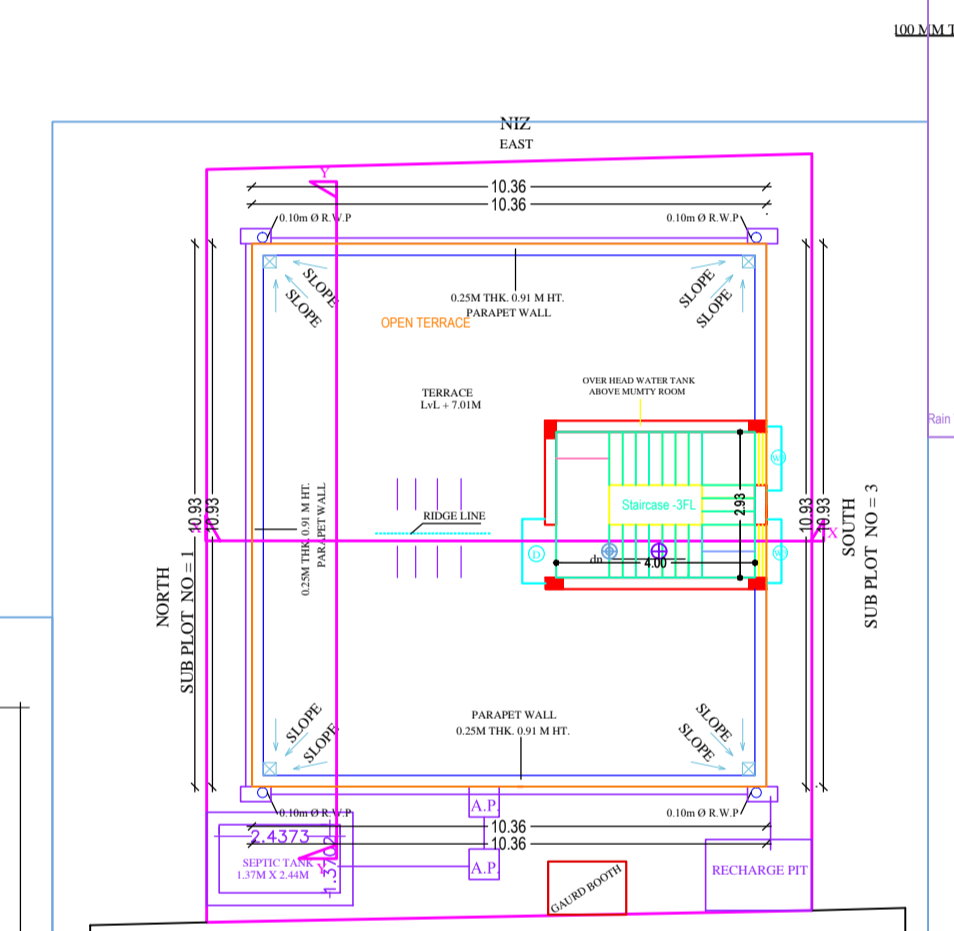
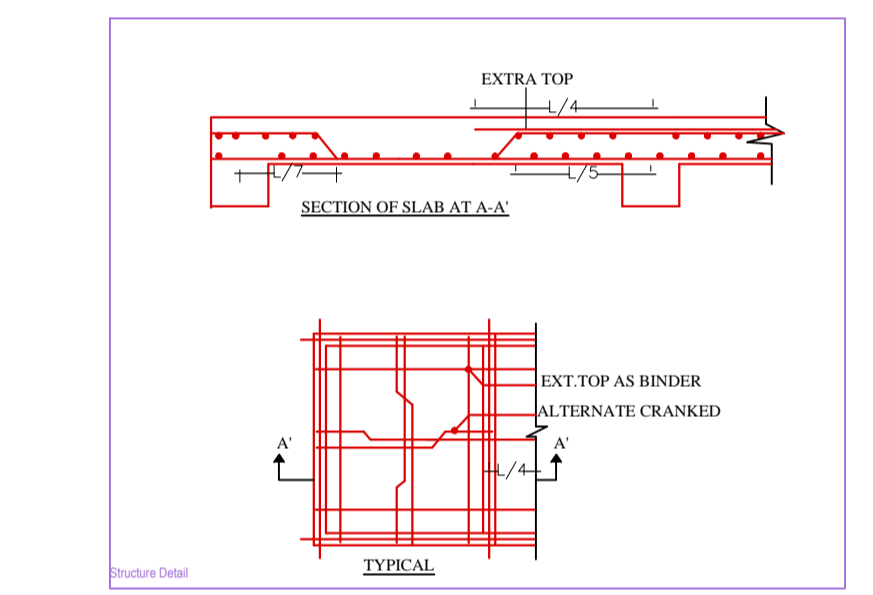
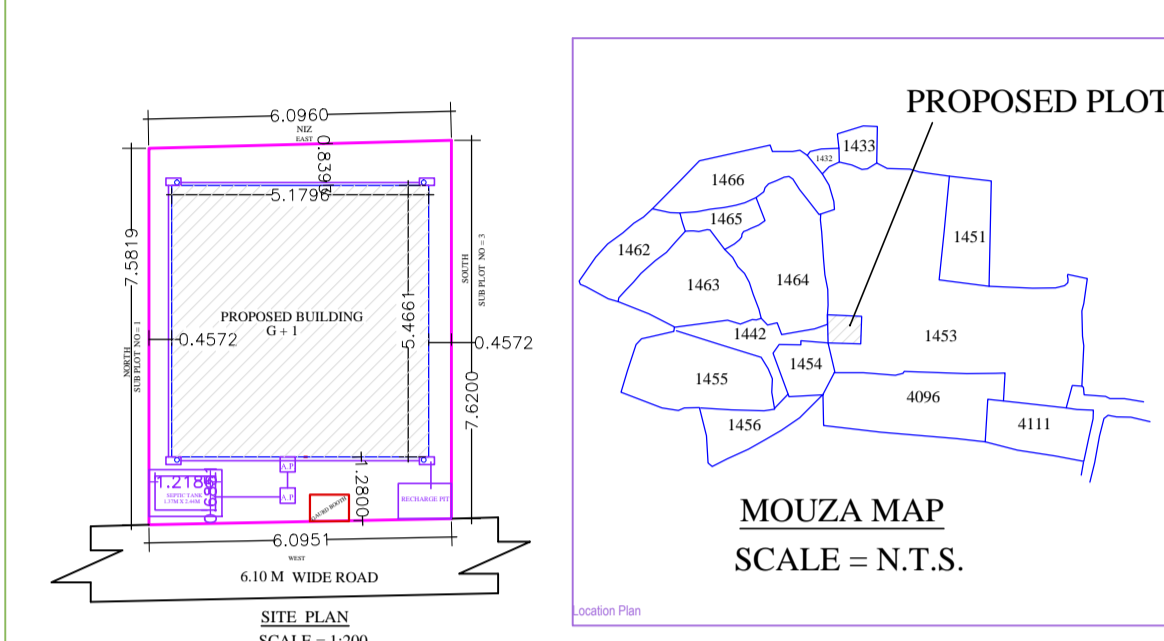
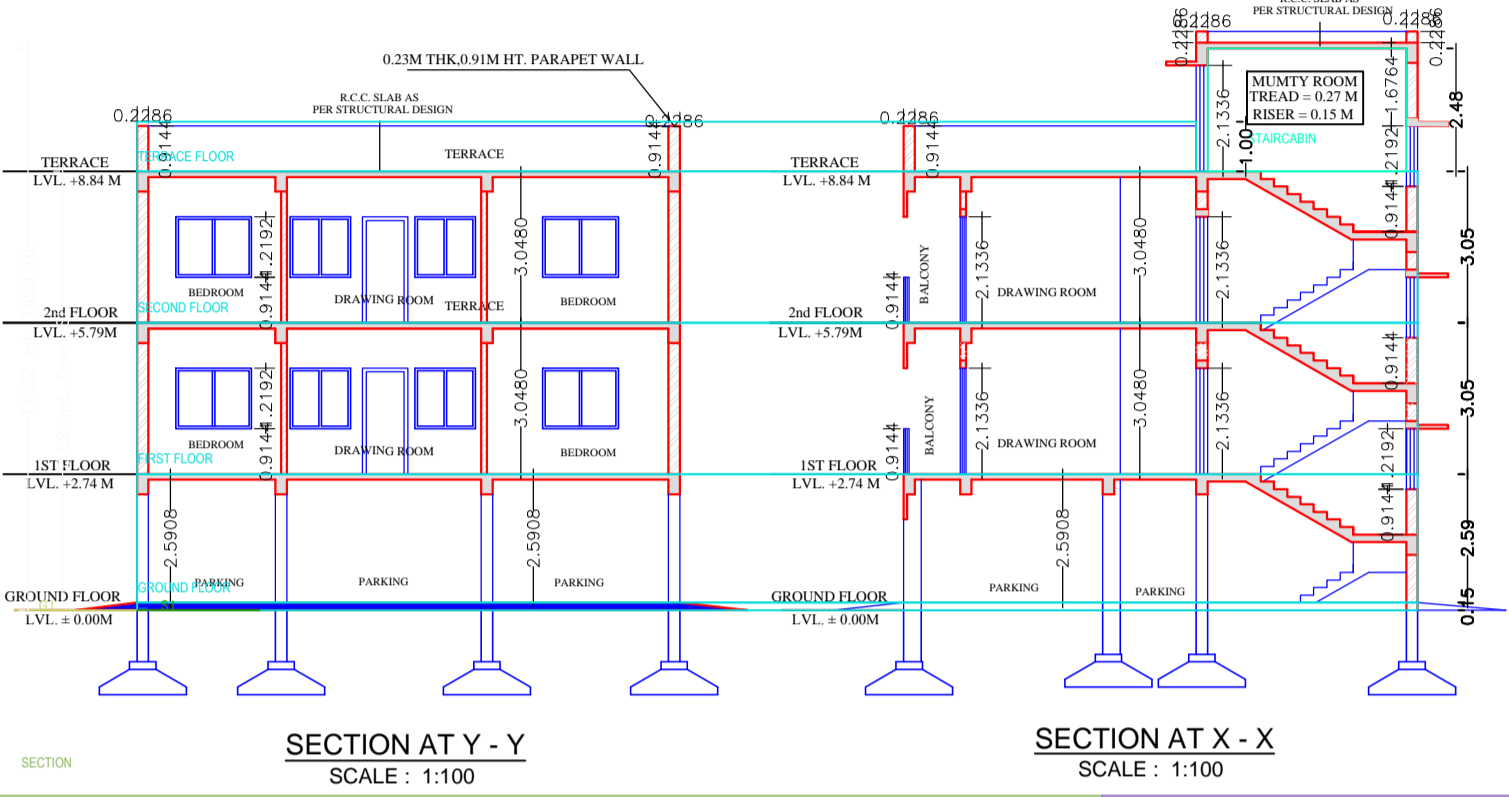
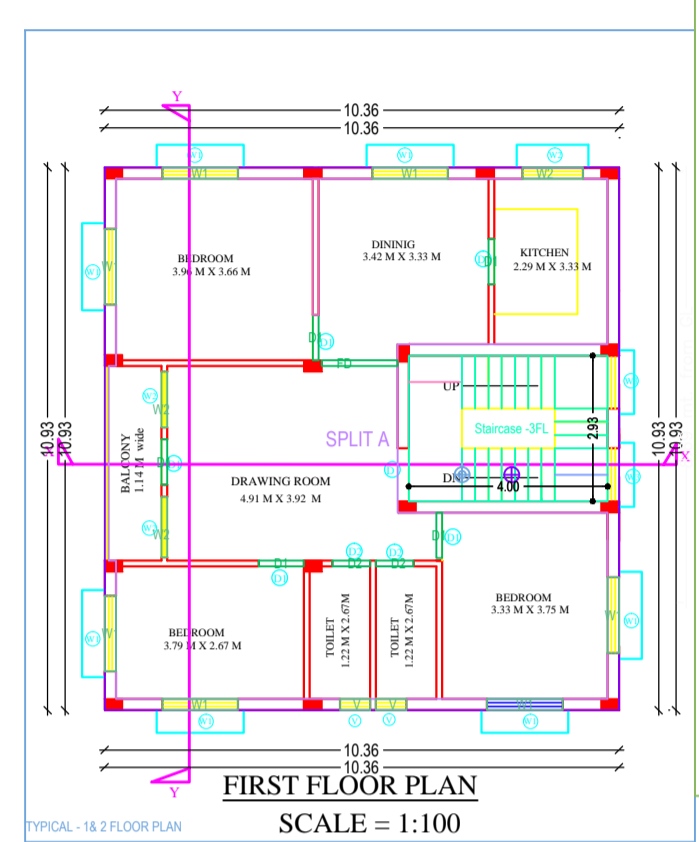
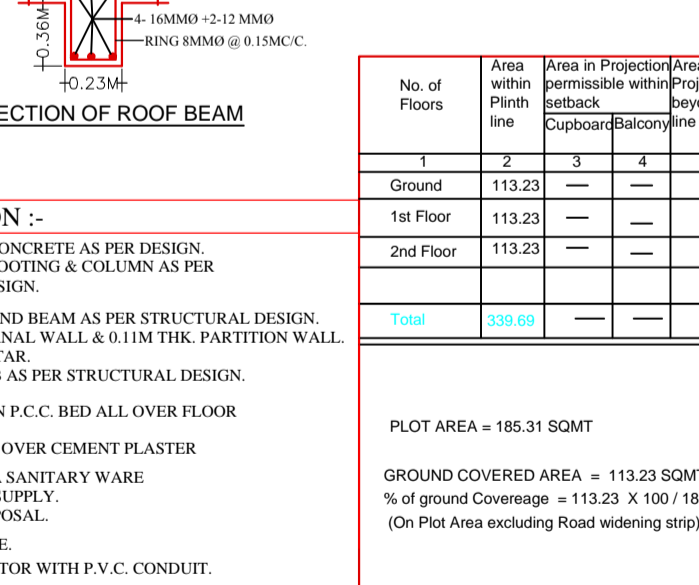
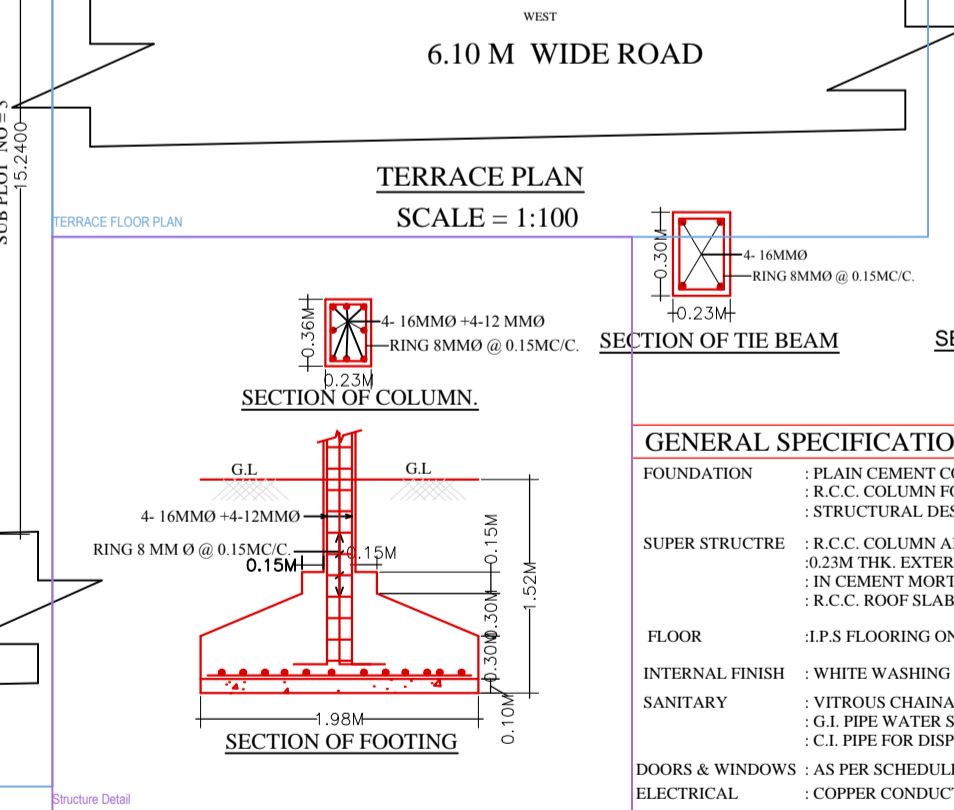


Project Title :SMT_NARMADA KUMARI

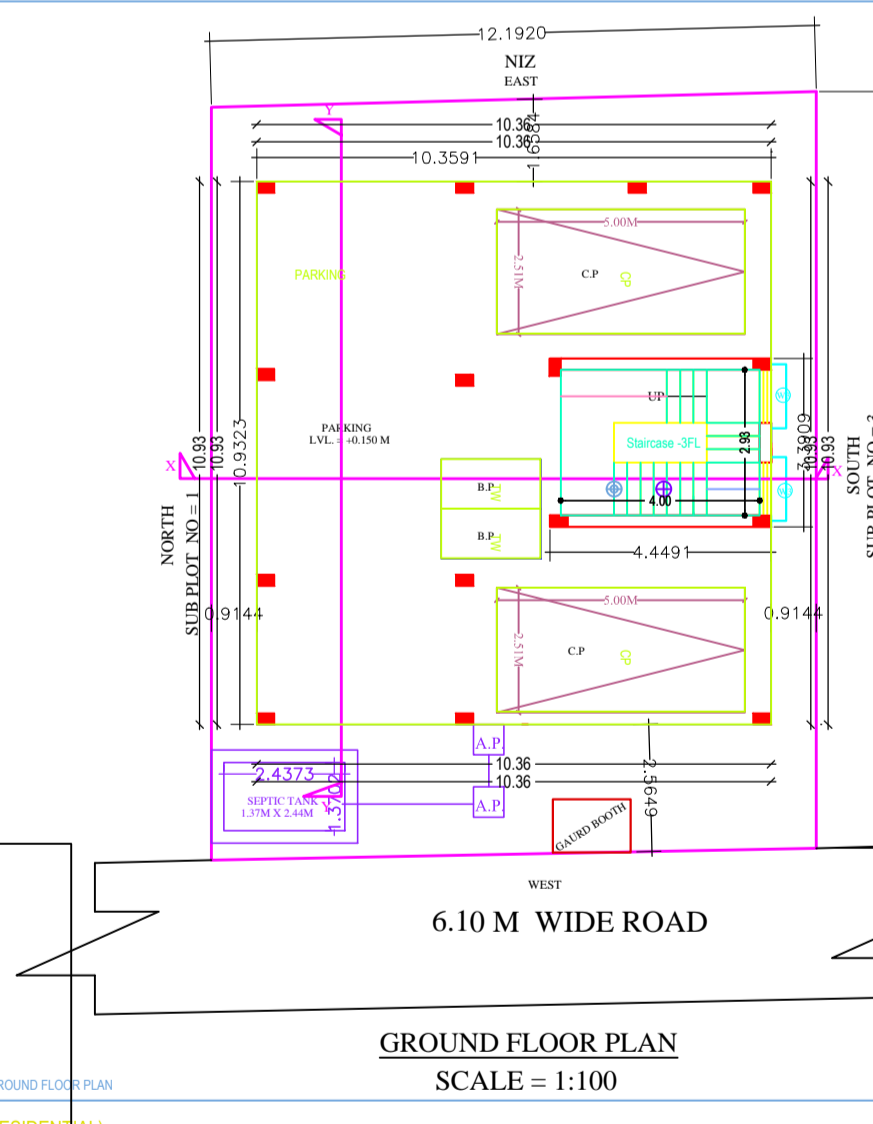

PROPOSED RESIDENTIAL BUILDING FOR
SMT. NARMADA KUMARI W/O PARAS NATH SINGH
PLOT NO - 1453
KHATA NO - 425
MOUZA - BALIGUMA
WARD NO - 110
THANA NO - 1150
P.S./P.O - MANGO
DISTRICT - EAST SINGHBHUM

ALL FLOOR PLAN, SECTION, ELEVATION, LOCATION MAP,
SITE PLAN, & RAIN WATER HARVESTING DETAILS

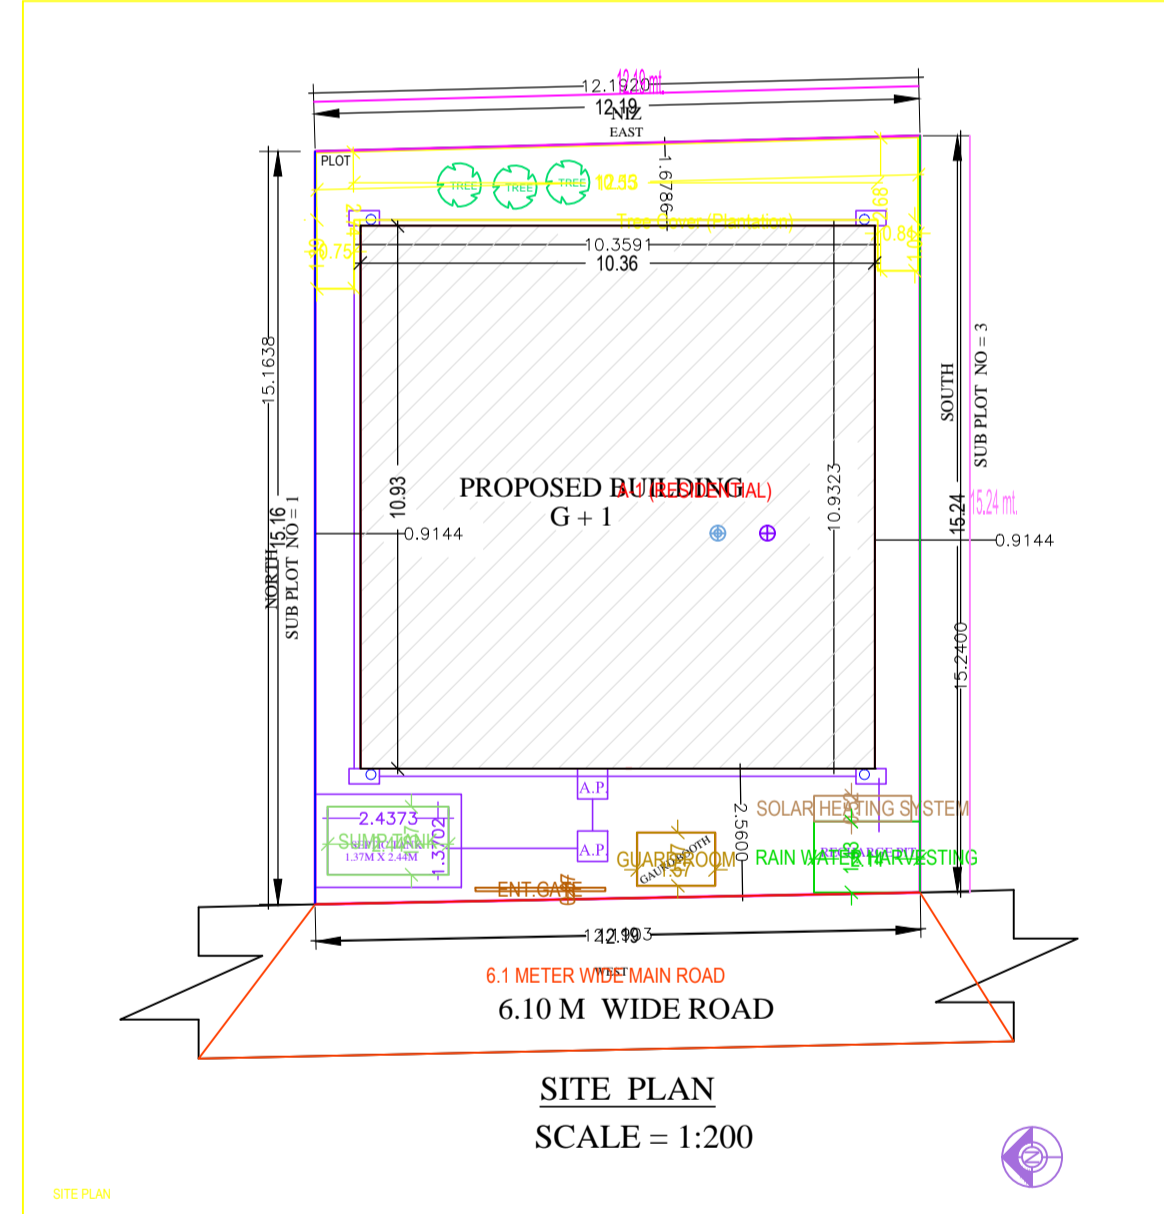

SCHEDULE OF OPENINGS

SL.NO.	MKD.	SIZE	DESCRIPTION
1.	D	1.07 X 2.13	Pannelled l/w single shutter door.
2.	D1	0.91 X 2.13	Pannelled l/w single shutter door.
3.	D2	0.76 X 2.13	Pannelled l/w single shutter door.
4.	W	1.52 X 1.22	Glazed steel framed window 4shutt.
5.	W1	1.22 X 1.22	Glazed steel framed window 2 shutt.
6.	W2	1.07 X 1.22	Glazed steel framed window 2 shutt.
7.	R.S.	As Per Site	Rolling Shutter
8.	V	0.61 X 0.61	Top hung steel ventilator.

No. of Floors	Area within Plinth line	Area in Projection within setback	Area in Projection Beyond plinth line	Total Area	Lit Well	Void	Duct	Parking	Other if Permissible	Total Deduc	Net Area for F.A.R.	Occupancy or Use Proposed	Remarks
1	---	---	---	---	---	---	---	---	---	---	---	---	---
Ground	113.23	---	---	113.23	---	---	---	---	---	98.15	15.08	PARKING	---
1st Floor	113.23	---	---	113.23	---	---	---	---	---	---	113.23	RESIDENCE	---
2nd Floor	113.23	---	---	113.23	---	---	---	---	---	---	113.23	RESIDENCE	---
Total	339.69	---	---	339.69	---	---	---	---	---	98.15	241.54		

GENERAL SPECIFICATION :-

FOUNDATION
PLAIN CEMENT CONCRETE AS PER DESIGN
R.C.C. COLUMN FOOTING & COLUMN AS PER STRUCTURAL DESIGN.

SUPER STRUCTURE
R.C.C. COLUMN AND BEAM AS PER STRUCTURAL DESIGN.
0.25M THK. EXTERNAL WALL & 0.1M THK. PARTITION WALL.
IN CEMENT MORTAR.
R.C.C. ROOF SLAB AS PER STRUCTURAL DESIGN.

FLOOR
1.P.S.FLOORING ON P.C.C. BED ALL OVER FLOOR.

INTERNAL FINISH
WHITE WASHING OVER CEMENT PLASTER

SANITARY
VITROUS CHAINA SANITARY WARE
G.I PIPE WATER SUPPLY.
C.I. PIPE FOR DISPOSAL.

DOORS & WINDOWS
AS PER SCHEDULE.

ELECTRICAL
COPPER CONDUCTOR WITH P.V.C. CONDUIT.

PLOT AREA = 185.31 SQMT
GROUND COVERED AREA = 113.23 SQMT.
% of ground Coverage = 113.23 x 100 / 185.31 = 61.10 %
(On Plot Area excluding Road widening strip)

F.A.R. = 241.54 / 185.31 = 1.30

SIGNATURE OF ARCHITECT / ENGINEER
SCALE : 1:100, 1: 200
SHEET NO.- 01 OF 01

SIGNATURE OF OWNER

APPROVAL (MNAC)

Building A (RESIDENTIAL)