



GROUND FLOOR
SCALE 1:100

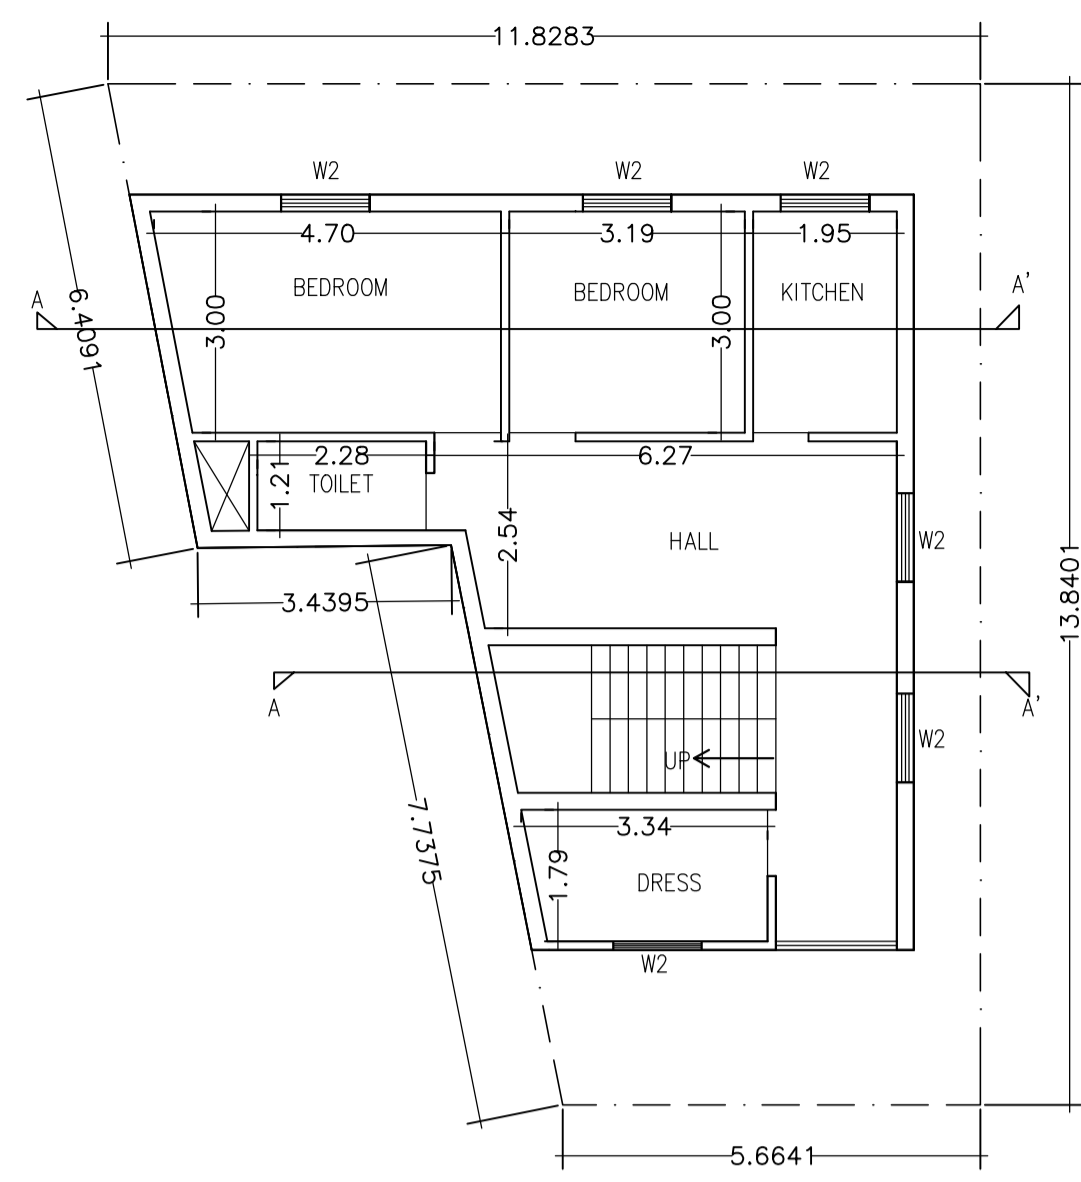

FIRST FLOOR
SCALE 1:100

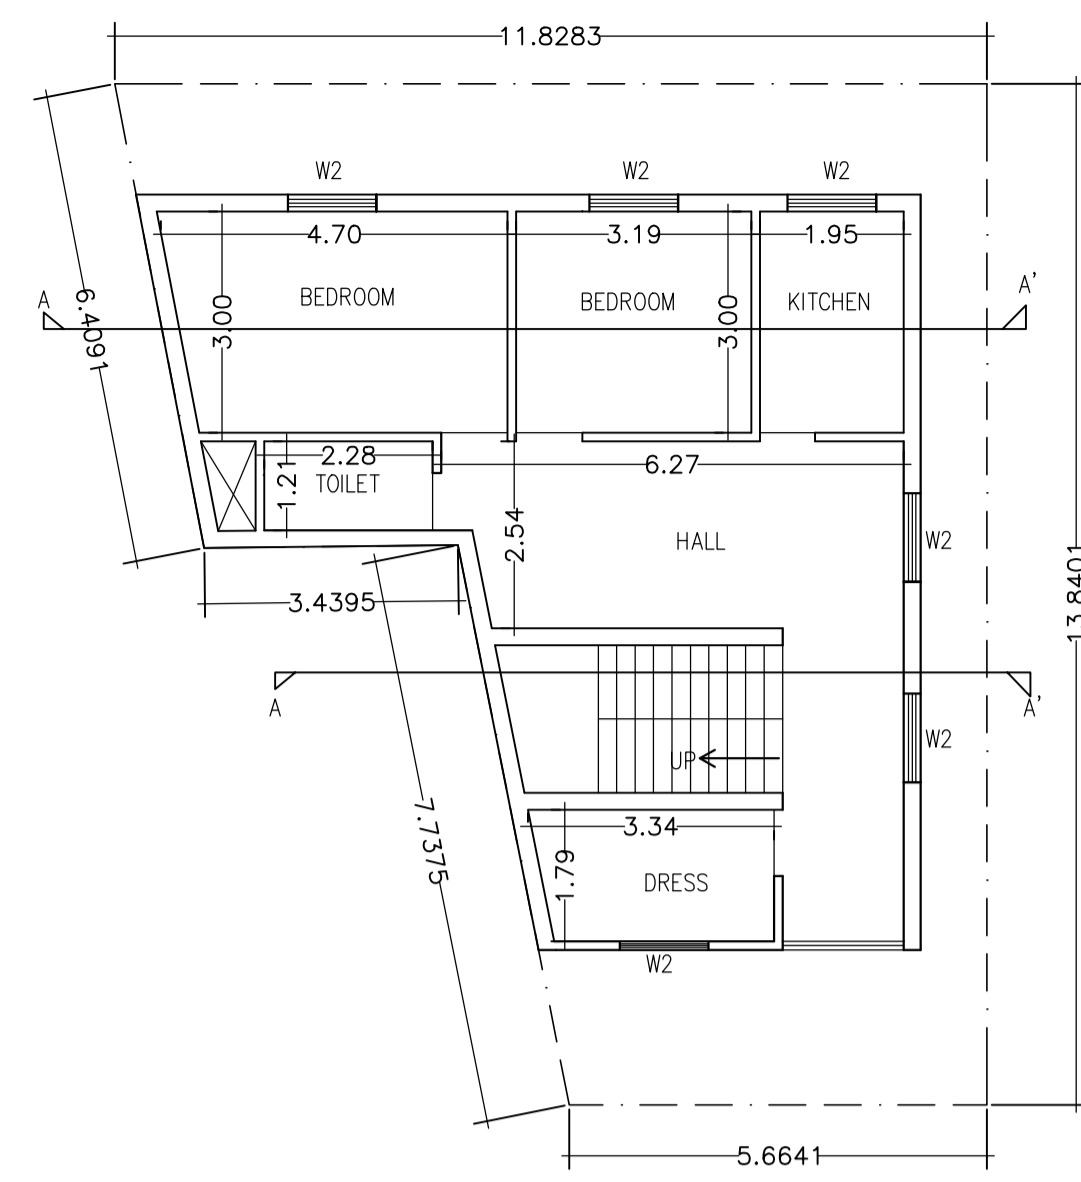


SECOND FLOOR
SCALE 1:100

DOOR WINDOW AND VENTILATION DETAIL						
S/No	TYPE	LENTH	HEIGHT	SILL LEV.	LINTEL LEV.	DESCRIPTION
1	D	1.20M	2.10M	0.00	2.1	SOLID CORE FLUSH DOOR
2	D1	0.90M	2.10M	0.00	2.1	SOLID CORE FLUSH DOOR
3	D2	0.75M	2.10M	0.00	2.1	SOLID CORE FLUSH DOOR
4	W6	1.80M	1.20M	0.90	2.1	FULLY GLASSED STEEL WINDOW
5	W4	1.20M	1.20M	0.90	2.1	FULLY GLASSED STEEL WINDOW
6	W3	0.90M	1.20M	0.90	2.1	FULLY GLASSED STEEL WINDOW
7	Wk	0.90M	1.20M	0.90	2.1	FULLY GLASSED STEEL WINDOW
8	V	0.60M	0.60M	1.50	2.1	FULLY GLASSED VENTILATOIN


Note- this detail is applicable in all floor.

NOTE:
1. FOUNDATION & R.C.C. AS PER STRUCTURAL ENGG. SPECIFICATION
2. ALL EXISTING STRUCTURE TO BE DEMOLISHED
3. ALL DIMENSIONS IN Mtrs.
4. DRAWING NOT TO BE SCALED


OFFICE USE

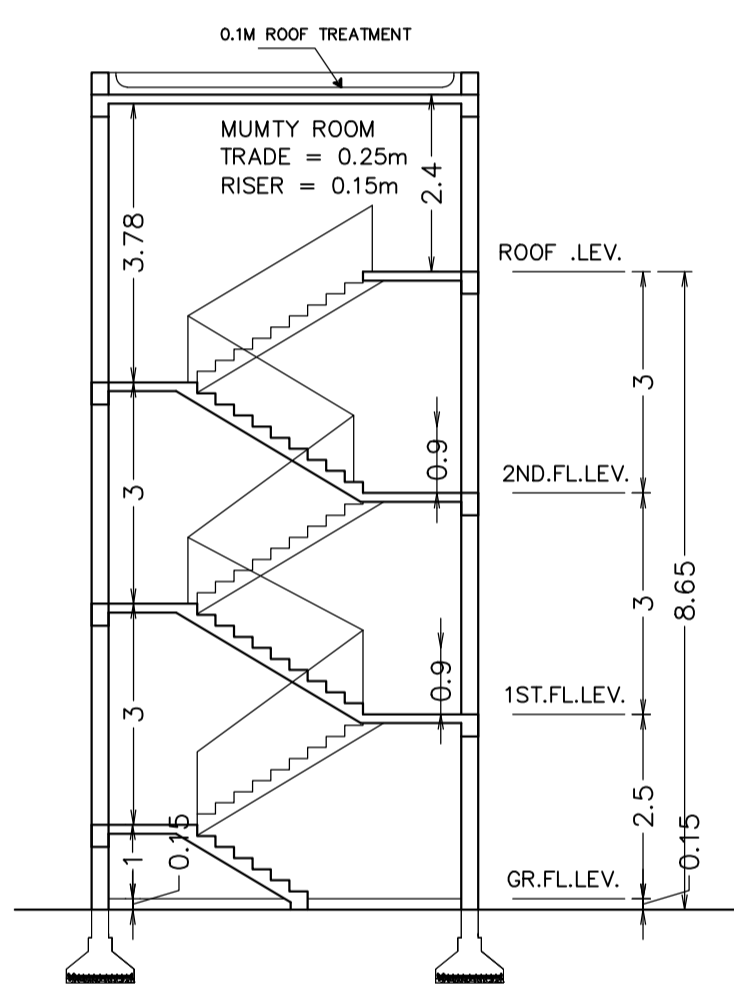


SECTION -X-X'
SCALE : 1:100

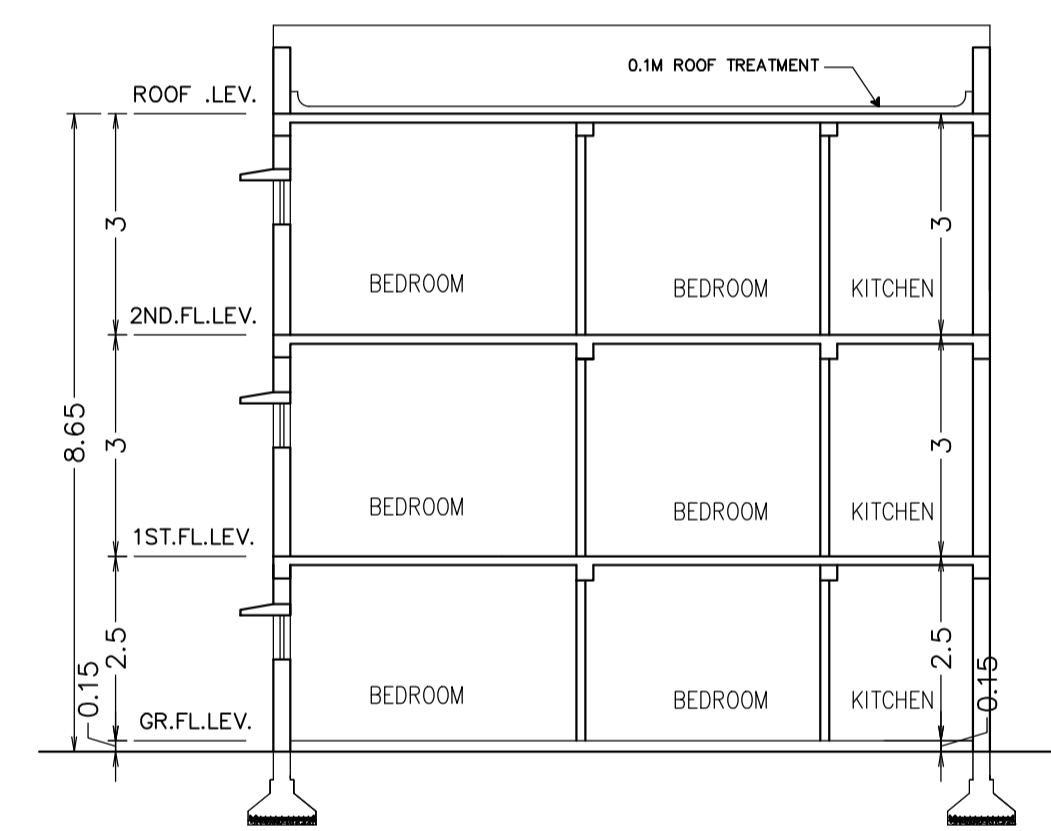

SECTION -Y-Y'
SCALE : 1:100

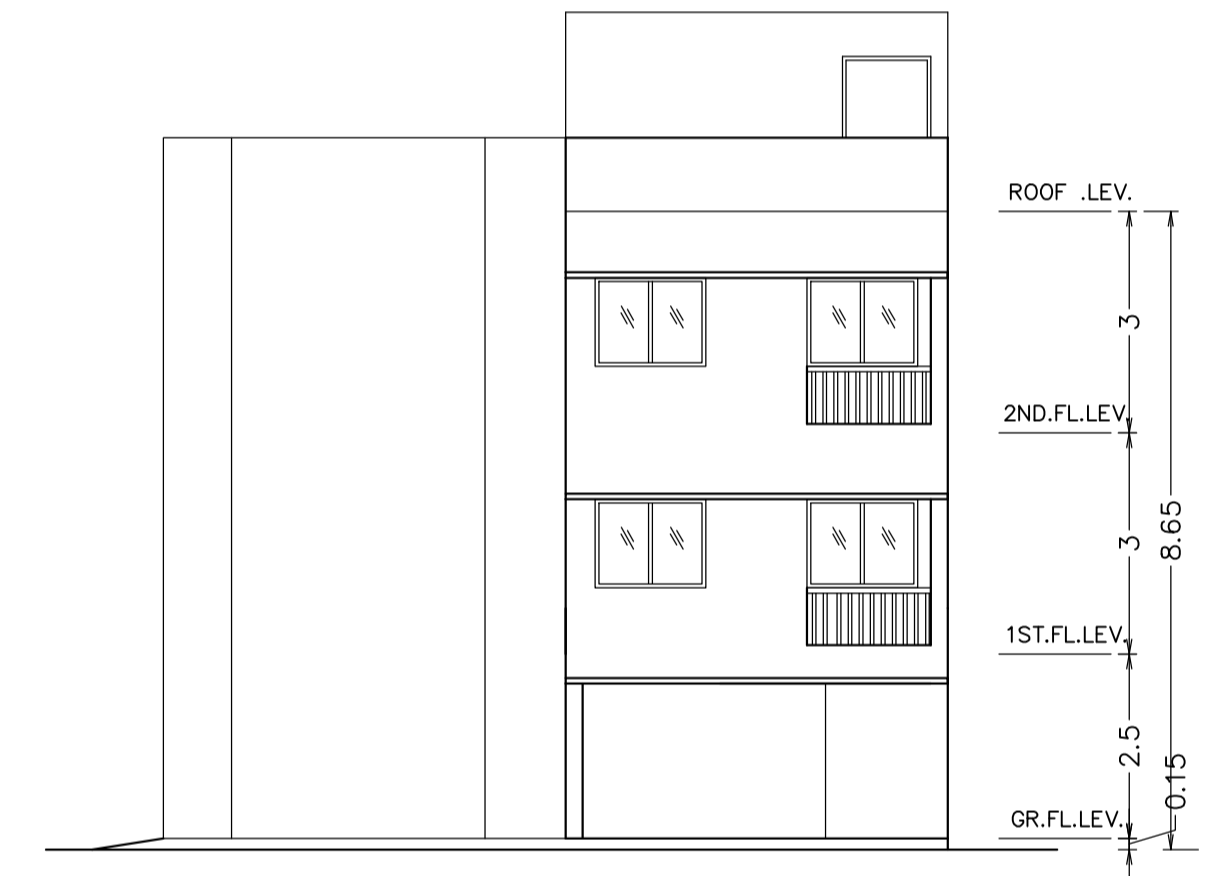

FRONT ELEVATION
SCALE : 1:100

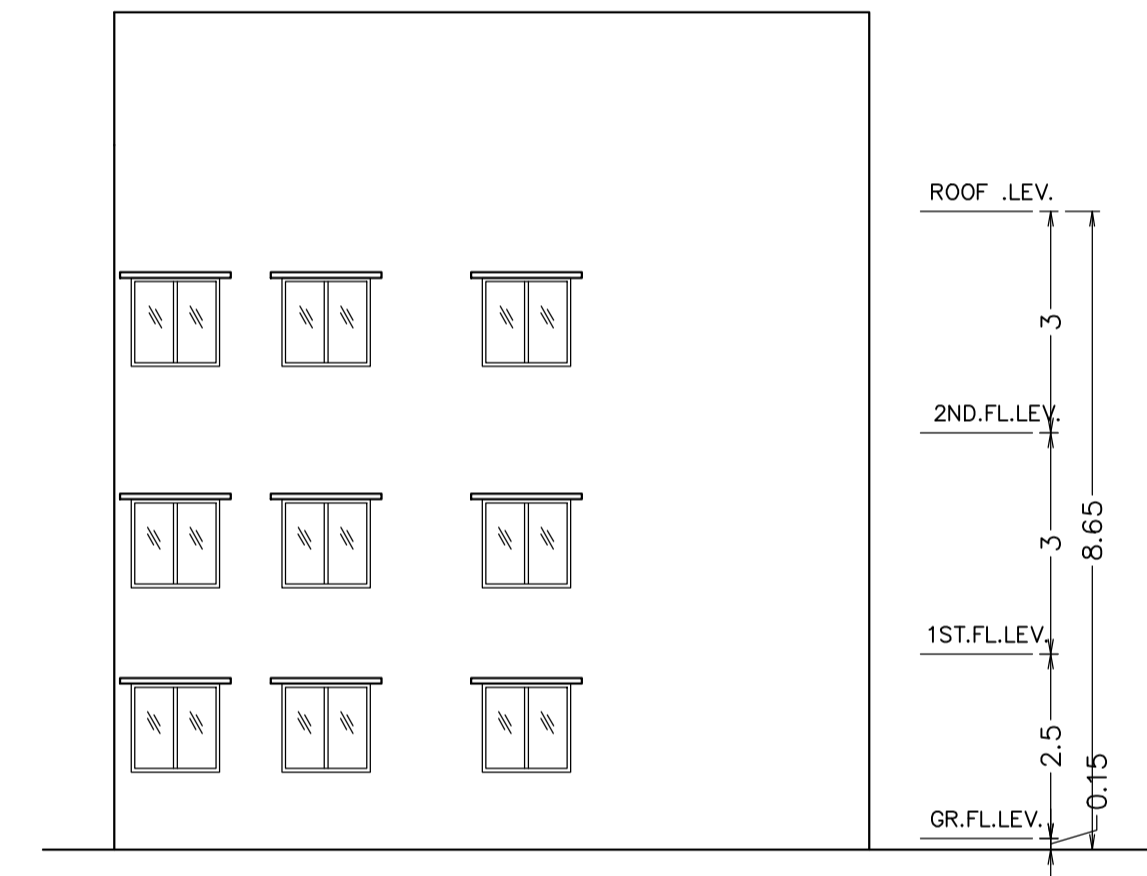

REAR ELEVATION
SCALE : 1:100


APPROVED:-

OWNER / POAH


Signature of Applicant:-

GENERAL SPECIFICATION :-


FOUNDATION : PLAIN CEMENT CONCRETE AS PER DESIGN.
: R.C.C. COLUMN FOOTING & COLUMN AS PER STRUCTURAL DESIGN.
: R.C.C. COLUMN & BEAM AS PER STR . DESIGN.
SUPER STRUCTRE 0.23M.THK. EXT. WALL & 0.125M.THK. PARTITION WALL IN CEMENT MORTAR.
: R.C.C. ROOF SLAB AS PER STRUCTURAL DESIGN.
FLOOR : CERAMIC TILES FLOOR AND DADO.
INTERNAL FINISH CEMENT PLASTER WITH P.O.P & O.B.D.
SANITARY : VITROUS CHAINA CLAY SANITARY WARE G.I. PIPE WATER SUPPLY.
: P.V.C PIPE FOR SEWAGE DISPOSAL.
DOORS & WINDOW AS PER SCHEDULE.
ELECTRICAL : COPPER WIRE WITH P.V.C. CONDUIT.

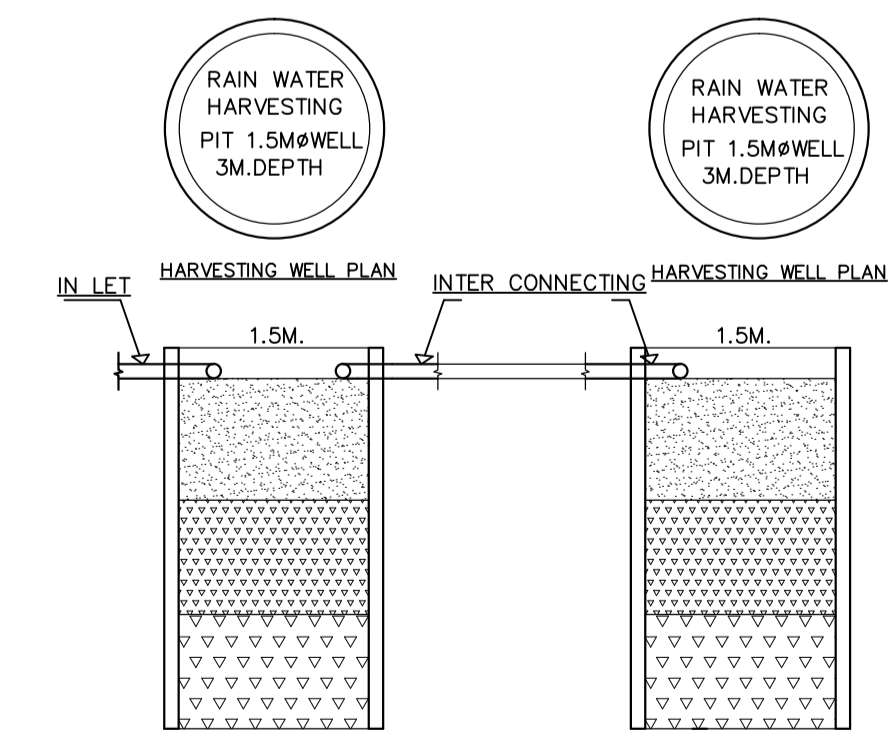

HARVESTING WELL SECTION

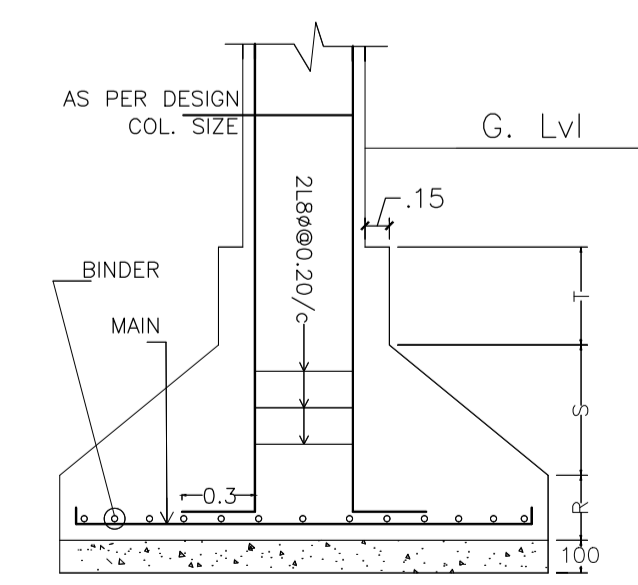

DETAIL OF COLUMN & FOOTING

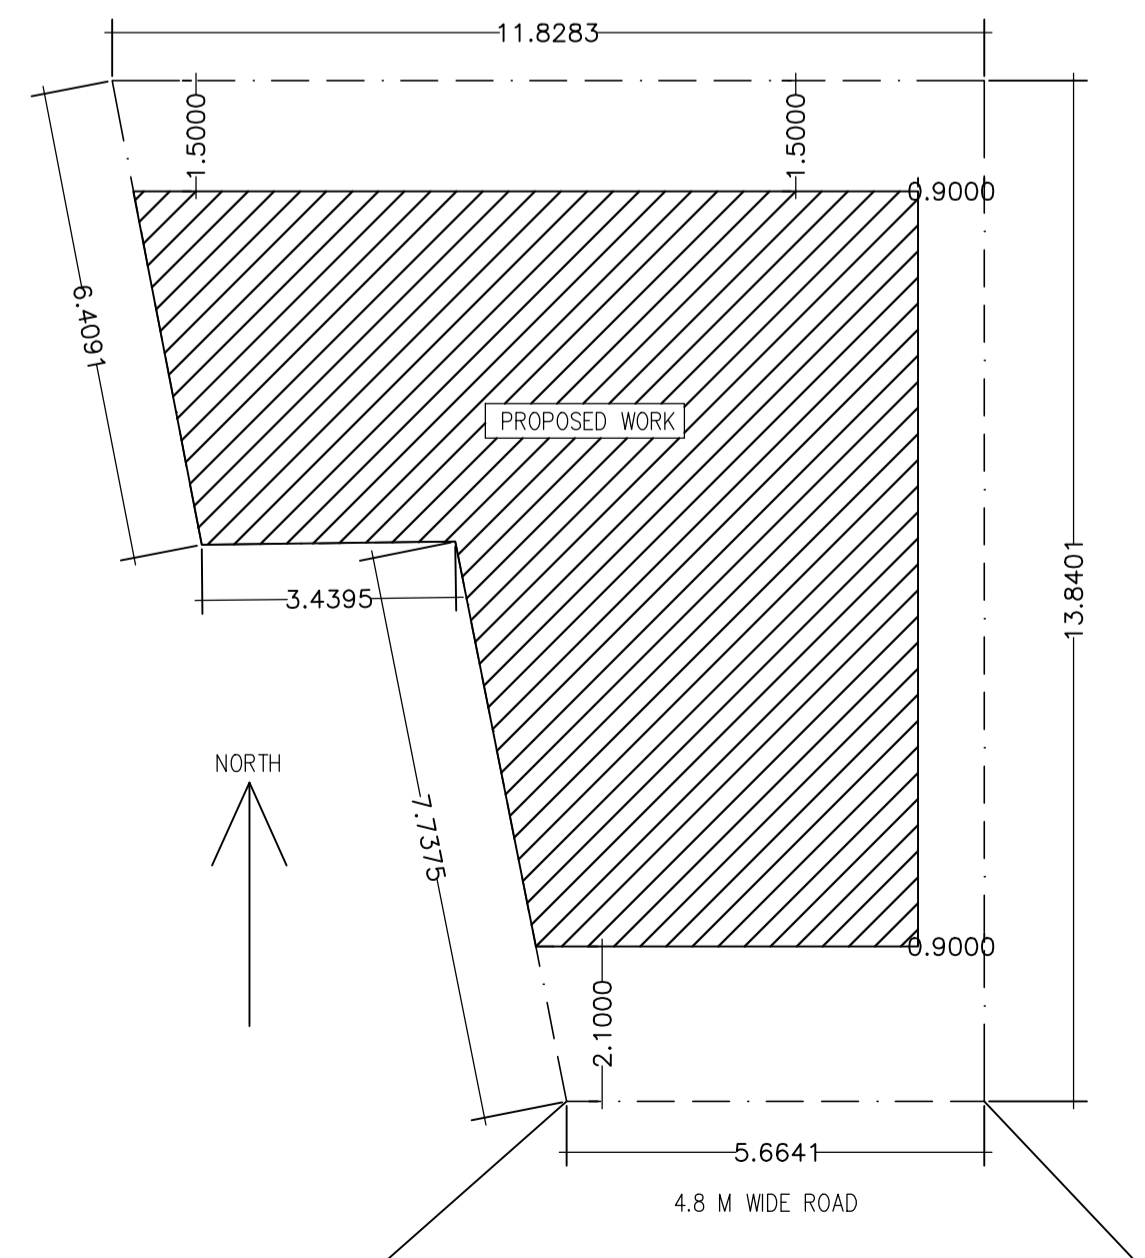

SITE PLAN
SCALE 1:100

AREA STATEMENT FOR RESIDENTIAL INDIVIDUAL BUILDING				
S/No.		EXISTING (In Sqm)	PROPOSED (In Sqm)	TOTAL (In Sqm)
1.	PLOT AREA	NIL	127.80	127.80
2.	GROUND COVERAGE	NIL	79.86	79.86
3.	GROUND FLOOR	NIL	79.86	79.86
4.	FIRST FLOOR	NIL	79.86	79.86
5.	SECOND FLOOR	NIL	79.86	79.86
TOTAL				239.38
7.	%GROUND COVERAGE	79.86 / 127.80 x 100 = 62.5 % < 70%		
8.	F.A.R. DETAIL	239.38 / 127.80 = 1.87		

WATER CONSUMPTION CALCULATION	
* WATER REQUIRED PER PERSON	- 130 Ltrs.
* TOTAL NUMBER OF PERSONS	- 6
* WATER REQD. FOR 6 PERSONS	- 6x130+10% = 858 Ltrs.
* PROVIDED	- 1000 Ltrs.

CALCULATION OF PARKING REQUIREMENTS	
* NO OF CAR PARKING REQD.	- 1 Nos.
* AREA REQD.	- 1x20 = 20 Sqm.
* PROVIDED	- 34.43 Sqm

PROPOSED RESIDENTIAL BUILDING PLAN OF
1. SRI. RAJEEV RANJAN BHARDWAJ
2. SRI.NITIN KUMAR
3. SANJEEV KUMAR JHA
S/O- LT. DIGAMBER JHA
ADARSH COLONY, POST OFFICE ROAD, MANGO
JAMSHEDPUR

ARCHITECT/ENGINEER
SANDEEP KUMAR DAS
MNAC/ENG/0011/2022

SHEET No- 01 / 01

Parsudih Jamshedpur