




FRONT ELEVATION
Scale - 1:100

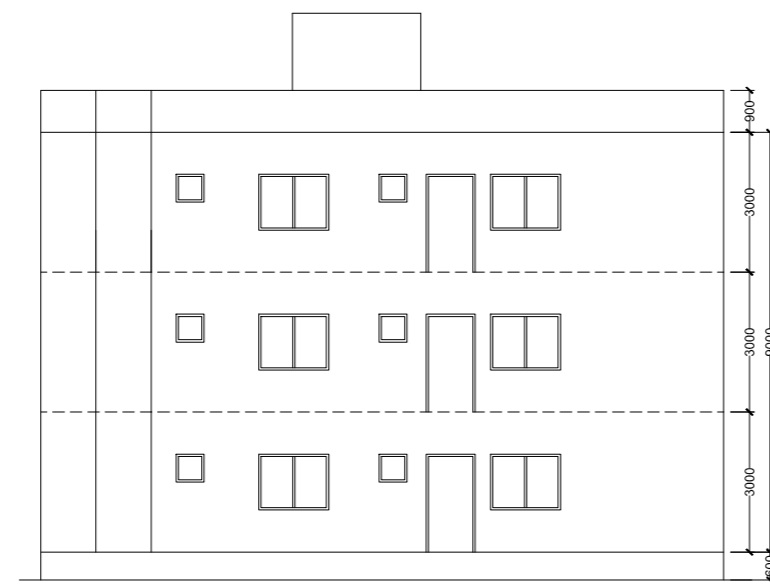


RIGHT SIDE ELEVATION
Scale - 1:100

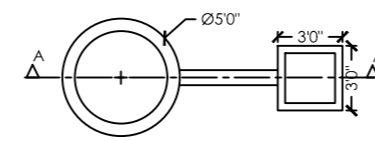


DETAIL OF GROUND WATER
RECHARGING PIT WITH SLIT TANK

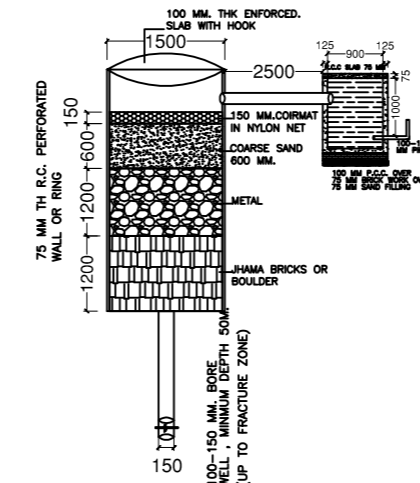


SECTION AT A-A (SCALE 1:50)

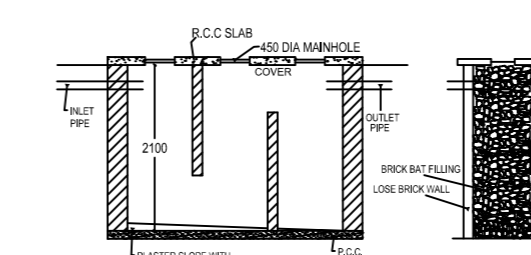


SECTION N-N.

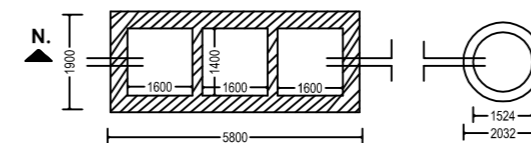


DETAIL OF SEPTIC TANK & SOAKPIT.

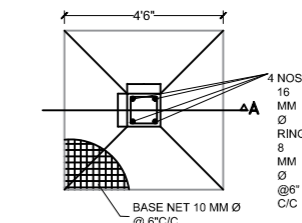


PLAN OF COLUMN FOUNDATION
SCALE= 1:50

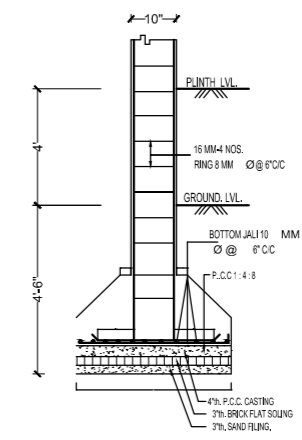


SECTION ON A-A
SCALE= 1:50

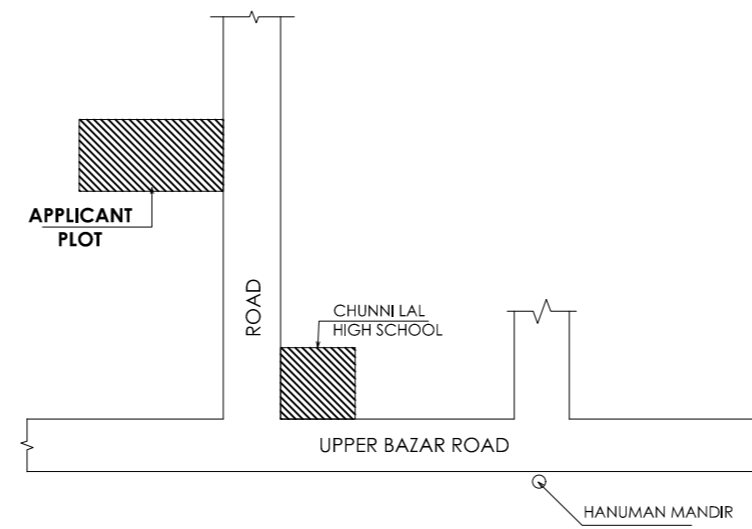


LOCATION PLAN
Scale - NTS

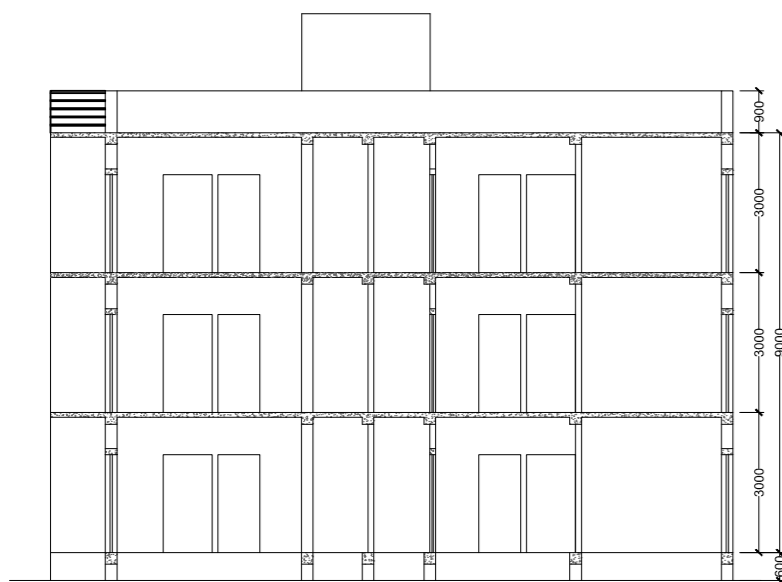


SECTION A-A
Scale - 1:100

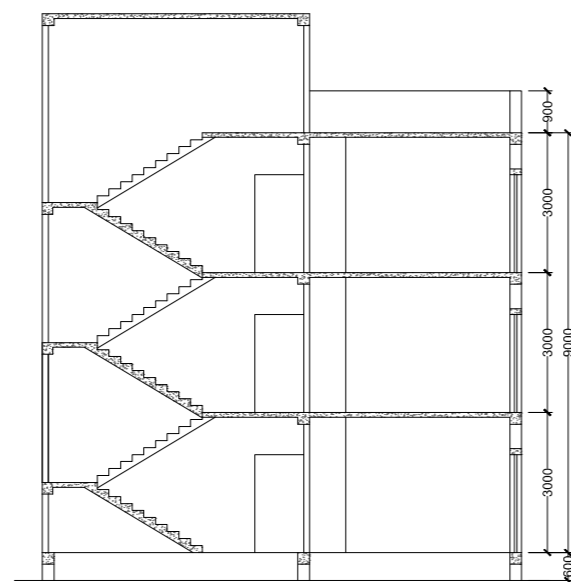


SECTION B-B
Scale - 1:100

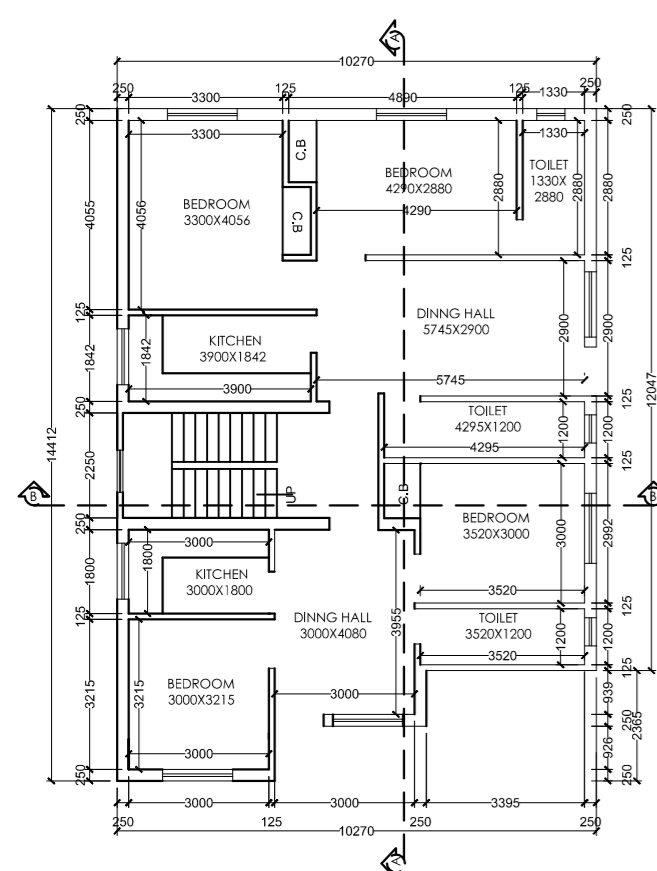


GROUND FLOOR PLAN
Scale - 1:100

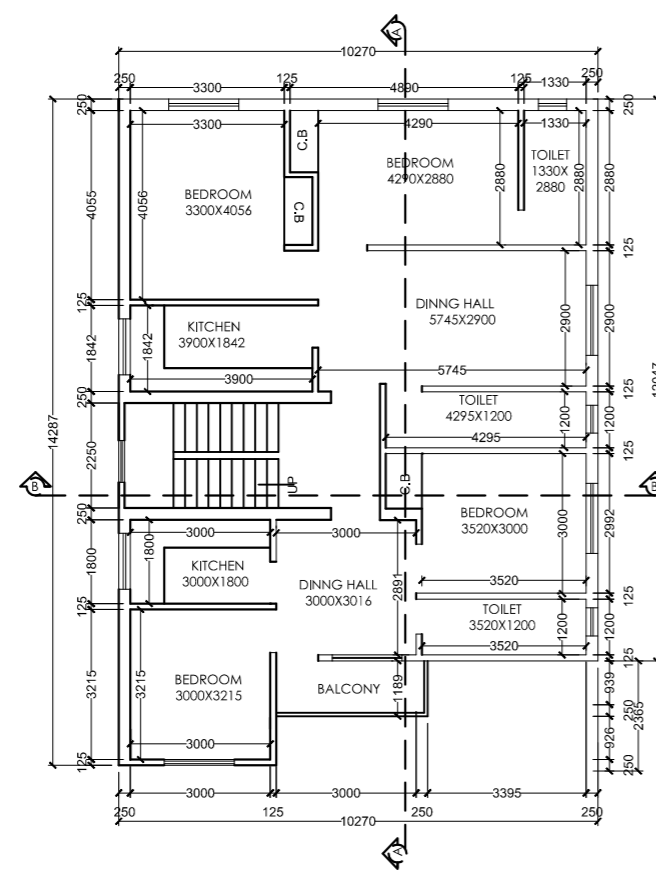


FIRST FLOOR PLAN
Scale - 1:100

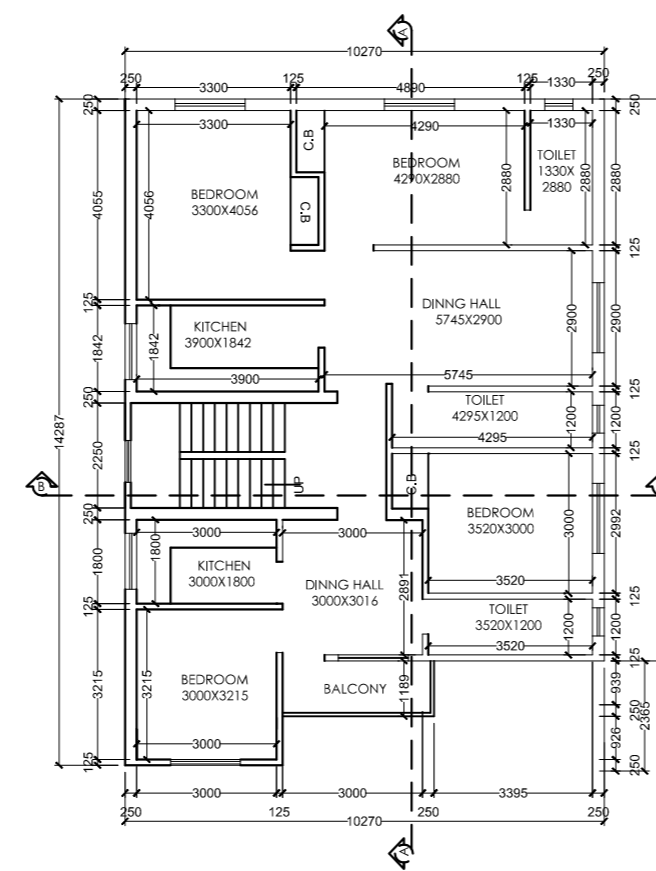

SECOND FLOOR PLAN
Scale - 1:100

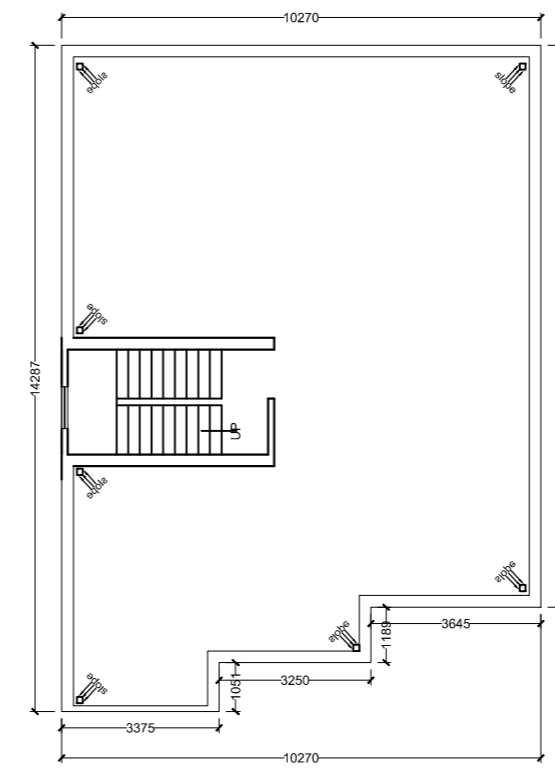

TERRACE FLOOR PLAN
Scale - 1:100

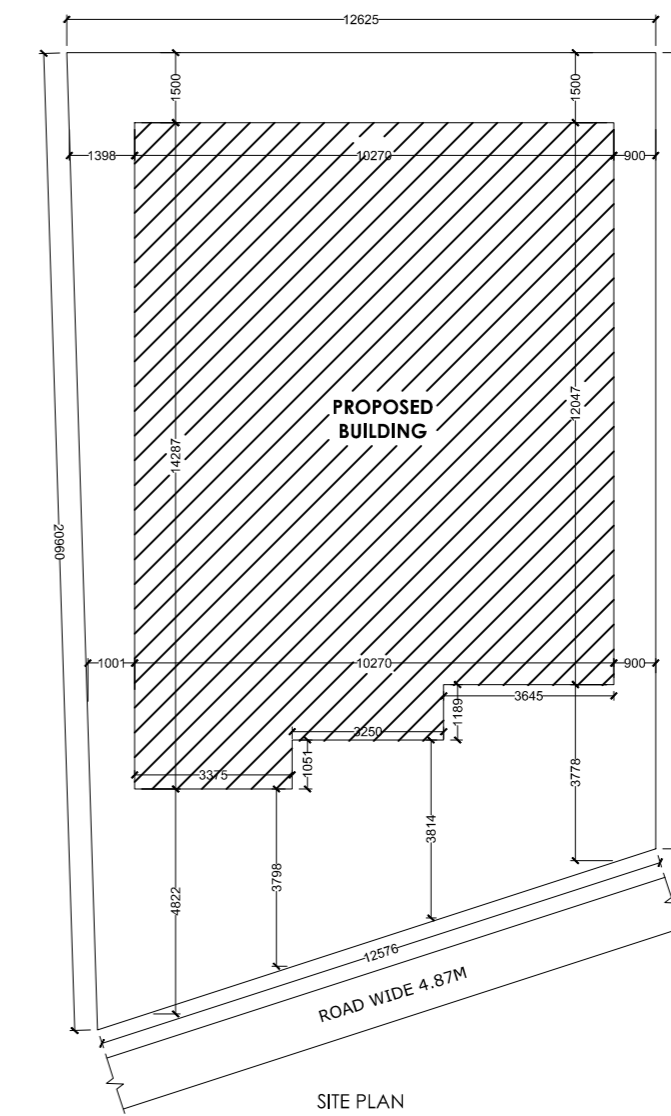

SITE PLAN
Scale - 1:100

General notes				
1	ALL DIMENSION ARE IN MILLIMETRES UNLESS OTHERWISE STATED.			
2	NO DIMENSION IS TO BE SCALED OFF THE DRAWING.			
3	DRAWINGS TO BE READ IN CONJUNCTION WITH ALL RELEVANT DRAWINGS & SPECIFICATIONS.			
4	REFER WRITTEN DIMENSIONS ONLY.			
5	DOORS AND WINDOW FRAME NOT TO BE FIXED ALONG WITH BRICK WORK.			
6	INTERNAL PLASTER SHOULD BE 12MM THICK AND EXTERNAL PLASTER IS 25MM THICK.			
7	FOUNDATION DEPTH UPTO GOOD SOIL.			
8	CEMENT MORTAR OF MK (1:6) FOR ENTIRE STRUCTURE AND PLASTER WORK.			
9	SEPTIC TANK WILL BE FLUSHING SYSTEM.			
10	ALL REINFORCEMENT SHALL BE OF TOR STEEL OF GRADE FY-415.			
11	GRADE OF CONCRETE SHALL BE M-20			

TYPE	WIDTH	HEIGHT	SILL LVL	DISCUPTION
D	1000	2100	NILL	SINGLE SHUTTER FLUSH DOOR
D1	1000	2100	NILL	" "
D2	900	2100	NILL	" "
D3	700	2100	NILL	" "
CG	1500	2100	NILL	STEEL CHANNEL GATE
W	1500	1200	900	4 LEAF GLAZED WIND
W2	1200	1200	900	" "
W3	900	1200	900	" "
V	600	300	2400	VENTILATOR

schedule of area		
PLOT AREA AS PER SITE	-	234.371 SQ.M.
AREA OF GROUND FLOOR	-	135.146 SQ.M.
AREA OF FIRST FLOOR	-	135.146 SQ.M.
AREA OF SECOND FLOOR	-	135.146 SQ.M.
TOTAL BUILD UP AREA	-	405.438 SQ.M.
% OF COVERED AREA	-	57.66%
TOTAL F.A.R. ACHIEVED	-	1.72

PROPOSED RESIDENTIAL BUILDING PLAN OF BHOLA PRASHAD , S/O LATE RAGHUVIR LAL, PLOT NO. :-2065/2067, KHATA NO. :- 00, THANA NO. :-194, WARD NO. :- 19, AREA :-6 DECIMAL, MAUZA :- LOHARDAGA, DIST - LOHARDAGA - 835302, STATE JHARKHAND

AFH GROUP
Architecture & Design
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Mobile No: 99304264642
E-mail:- mdatul.haque265@gmail.com

ISSUE ONLY FOR CLIENT			
SCALE	DATE	SHEET NO.	
1 : 100		01 OF 01	

CLIENT: _____ ENGINEER / ARCHITECT: _____