




FRONT ELEVATION
SCALE 1:100

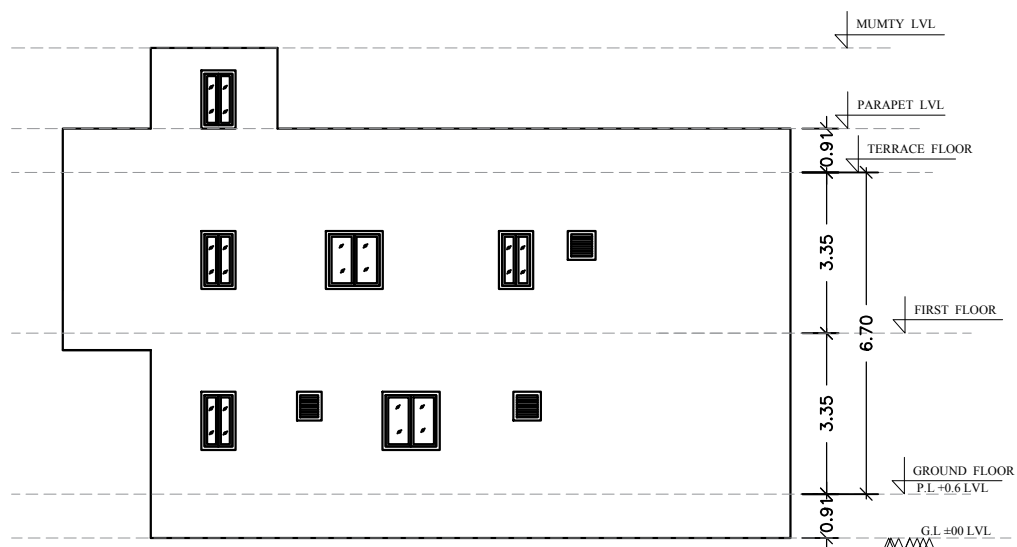


RIGHT ELEVATION
SCALE 1:100

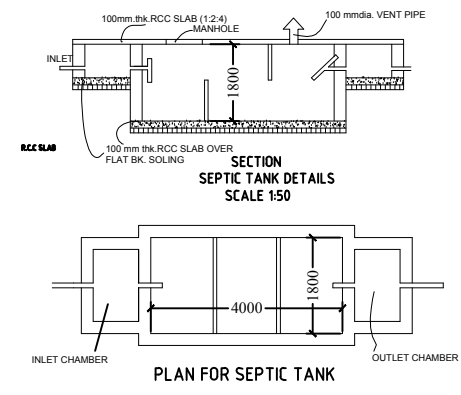

SEPTIC TANK DETAIL

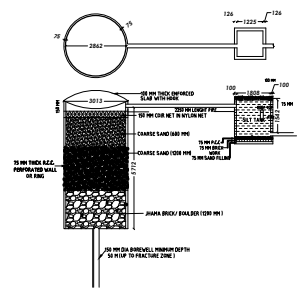


RAINWATER HARVESTING
N.T.S.

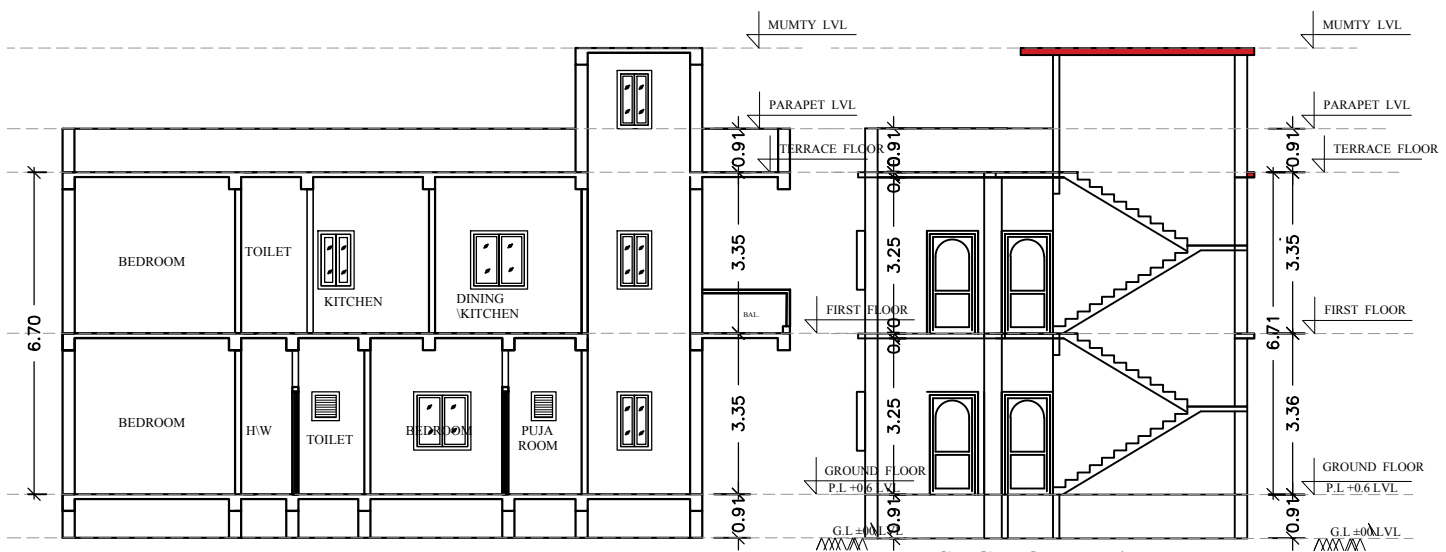

SECTION YY'
SCALE 1:100

SECTION XX'
SCALE 1:100

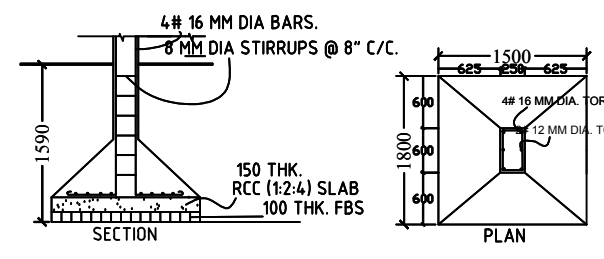

FOUNDATION DETAILS (ISOLATED R.C.C FOOTING)


- SPECIFICATIONS**
- FOUNDATION - R.C.C. COLUMN STRUCTURE
 - WALLS - 1st CLASS BRICK WORK IN RED BRICK IN CEMENT MORTAR 1:6
 - ALL COLUMN BEAM IN TORR STEEL & 1:1.5:3 CEM. CONCRETE
 - FLOORING - 1" I.P.S. 1:2:4 OVER FLAT BRICK SOLING AND MOSAIC AS PER REQUIREMENT.
 - R.C.C. ROOF SLAB 100 MM THK IN M 20
 - STAIR WAIST SLAB 4" THK, STEPS 300 X 150.
 - CHHAJJA 3" THK 0.54 WIDE IN R.C.C. 1:2:4.
 - PLASTER 1/2" THK 1:8 INSIDE & 1:6 OUTSIDE CEILING 1/4" THK IN 1:4
 - WOOD WORK 1 1/2 THK FLUSH DOORS, WINDOWS IN STEEL GLAZED AS PER DESIGN

DOOR / WINDOW SCHEDULE


S.NO	TYPE	WIDTH	HEIGHT	LINTEL	DESCRIPTION
1	W				2.13
2	W1				2.13
3	W2				2.13
4	V				2.13
5	V				2.13
6	D				2.74
7	D1				2.74
8	D2				2.74
9	D3				2.74
10					2.74
11					2.74
12					2.74
13					2.74

FAR CALCULATION


S.No	Area	Volume
1		
2		
3		
4		
5		
6		
7		
8		
9		
10		
11		
12		
13		
14		2.74

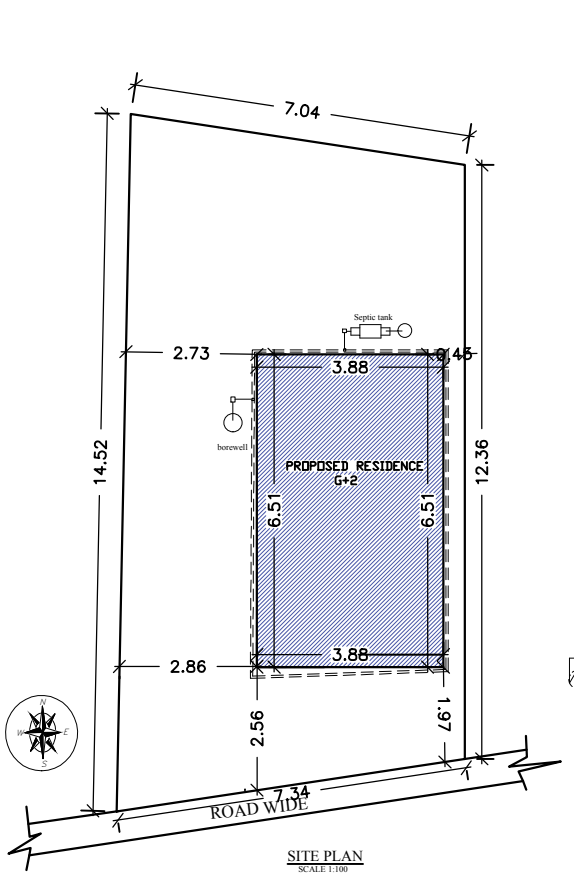


SITE PLAN
SCALE 1:100

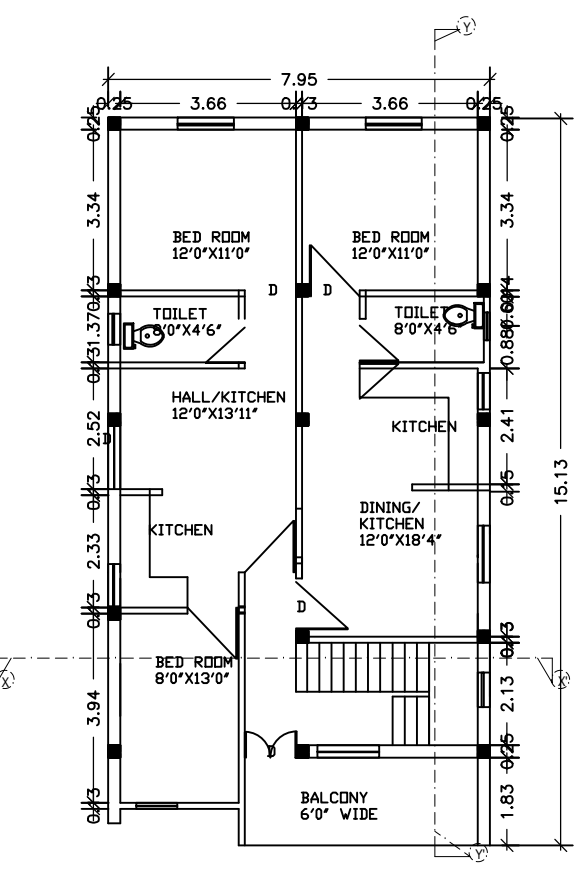

FIRST FLOOR PLAN
SCALE 1:100

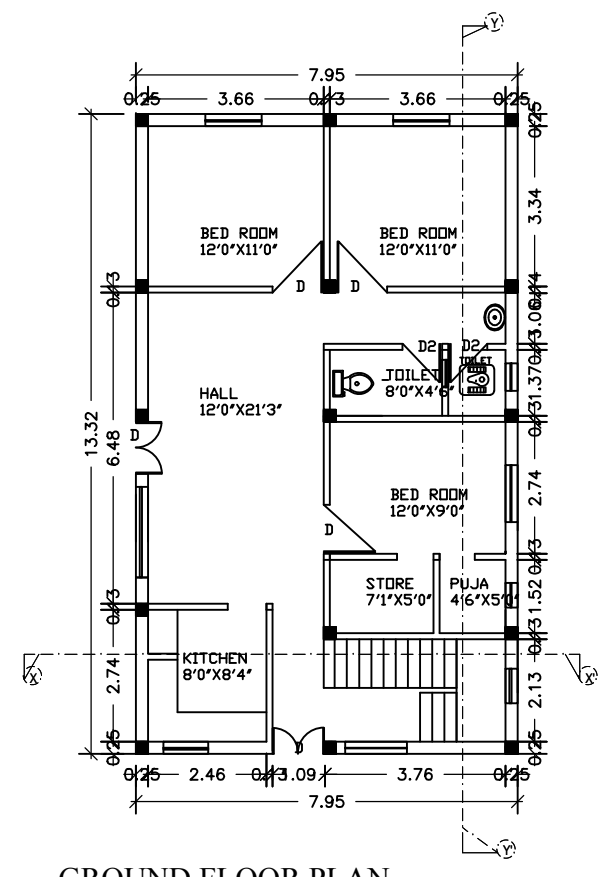

GROUND FLOOR PLAN
SCALE 1:100

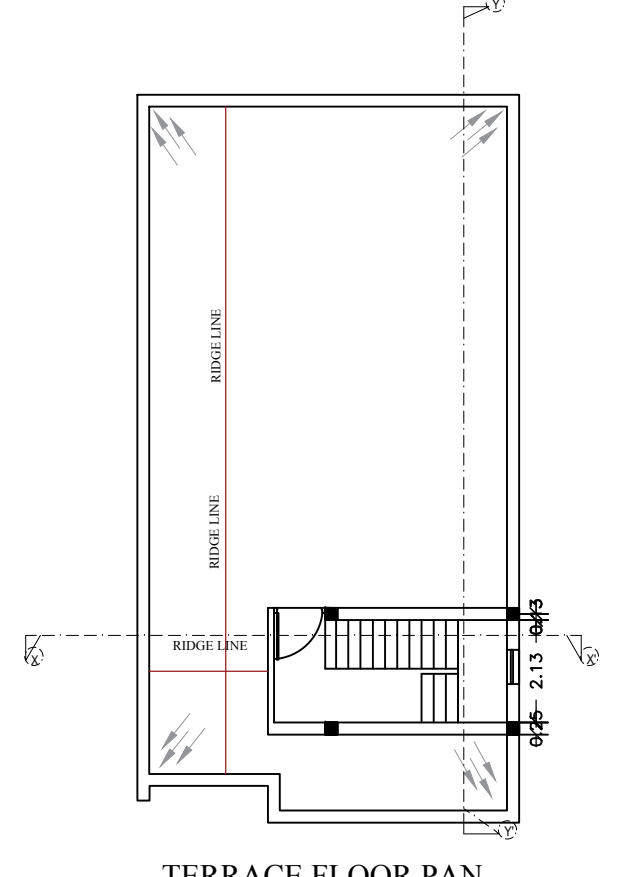

TERRACE FLOOR PAN
SCALE 1:100

SHEET NO.
1/1



SIGNATURE OF ARCHITECT

SIGNATURE OF OWNER