
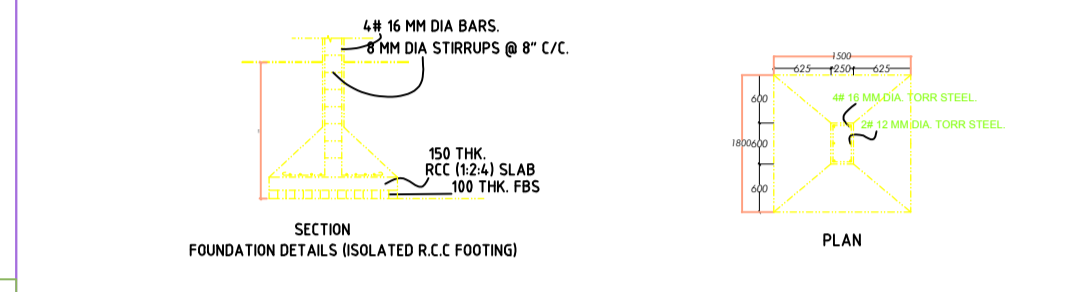
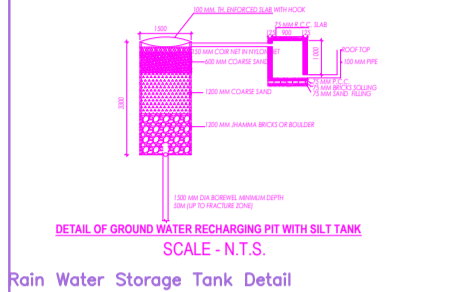
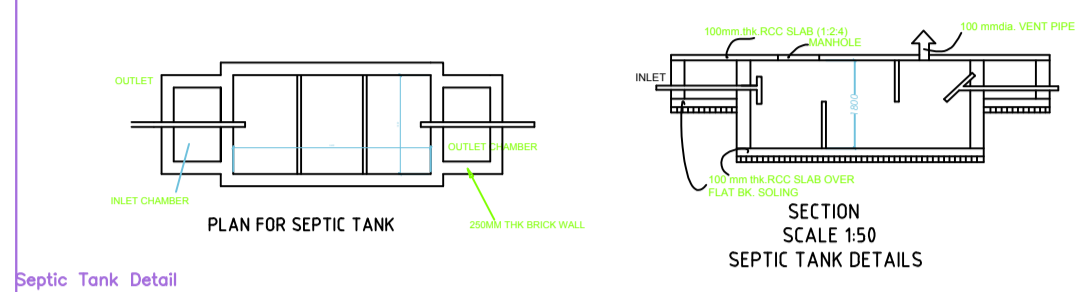




Project Title :PROPOSFD RESIDENTIAL BUILDING G+1 OF NFHA KHATOON

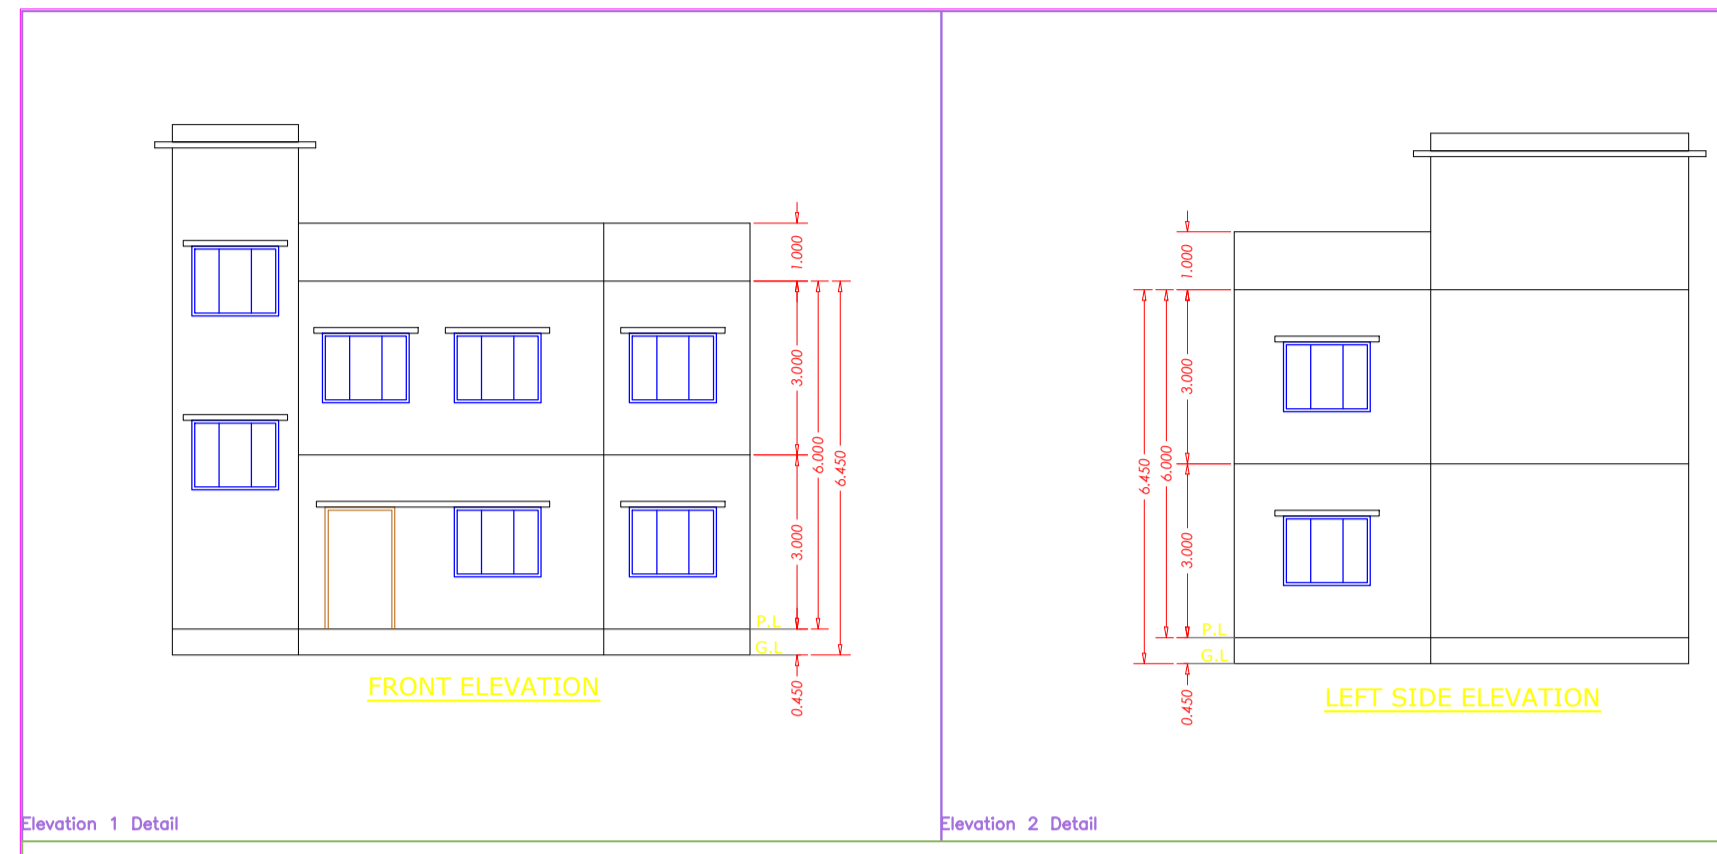

CERTIFICATE
This is to certify that the structural design of this building will be as per IS 1893-1984 & IS226-1993 and is safe to the same Earth quake resistant.

BRIEF SPECIFICATION

- BRICK WORK IN FOUNDATION AND SUPERSTRUCTURE.
- FIRST CLASS BRICK WORK IN CEMENT MORTAR (1:1.6)
- D.P.C. - D.P.C. IN CEMENT CONCRETE (1:2-4)
- FLOOR - (a) 1st I.P.S. (b) MODULAR FLOORING.
- ROOF - 5th THK. R.C.C. ROOF (1:1.5:3)
- LINTEL BAND AT F.L.V.L. - 6th THK. R.C.C. LINTEL (1:1.5:3)
- STAIRS - RISE - 4", TREAD - 10"
- DOORS - D-3'3"x7'0", D1-3'0"x7'0", D2-2'6"x7'0"
- WINDOWS - W-5'0"x4'0", W1-4'0"x4'0", W2-2'6"x4'0"
- VENTS - 2'0"x2'0"
- SAL WOOD FRAME & PAISAL WOOD SHUTTERS SHALL BE USED FOR DOOR.
- ALUMINIUM GLAZED WINDOW AND VENTILATORS WITH GUARD BARS SHALL BE USED.
- I.P.S. FLOOR SHALL BE USED OVER R.C.C. SLAB/P.C.C.
- ALL MASONRY SURFACES SHALL BE PLASTERED WITH CEMENT MORTAR 1:6 R.C.C. WITH CEMENT MORTAR 1:4 IN ROOF
- ALL STEEL AND WOOD WORK SHALL BE PAINTED WITH SYNTHETIC PAINT.
- ALL SANITARY AND ELECTRICAL FITTINGS SHALL BE OF STANDERD AND COMMERCIAL QUALITY .

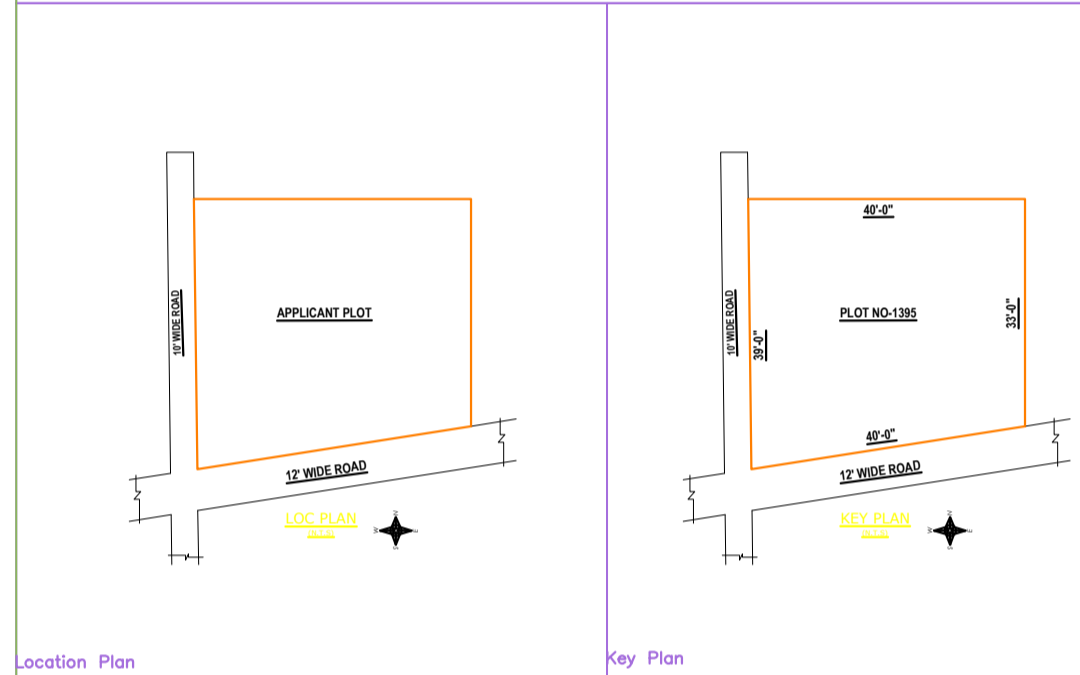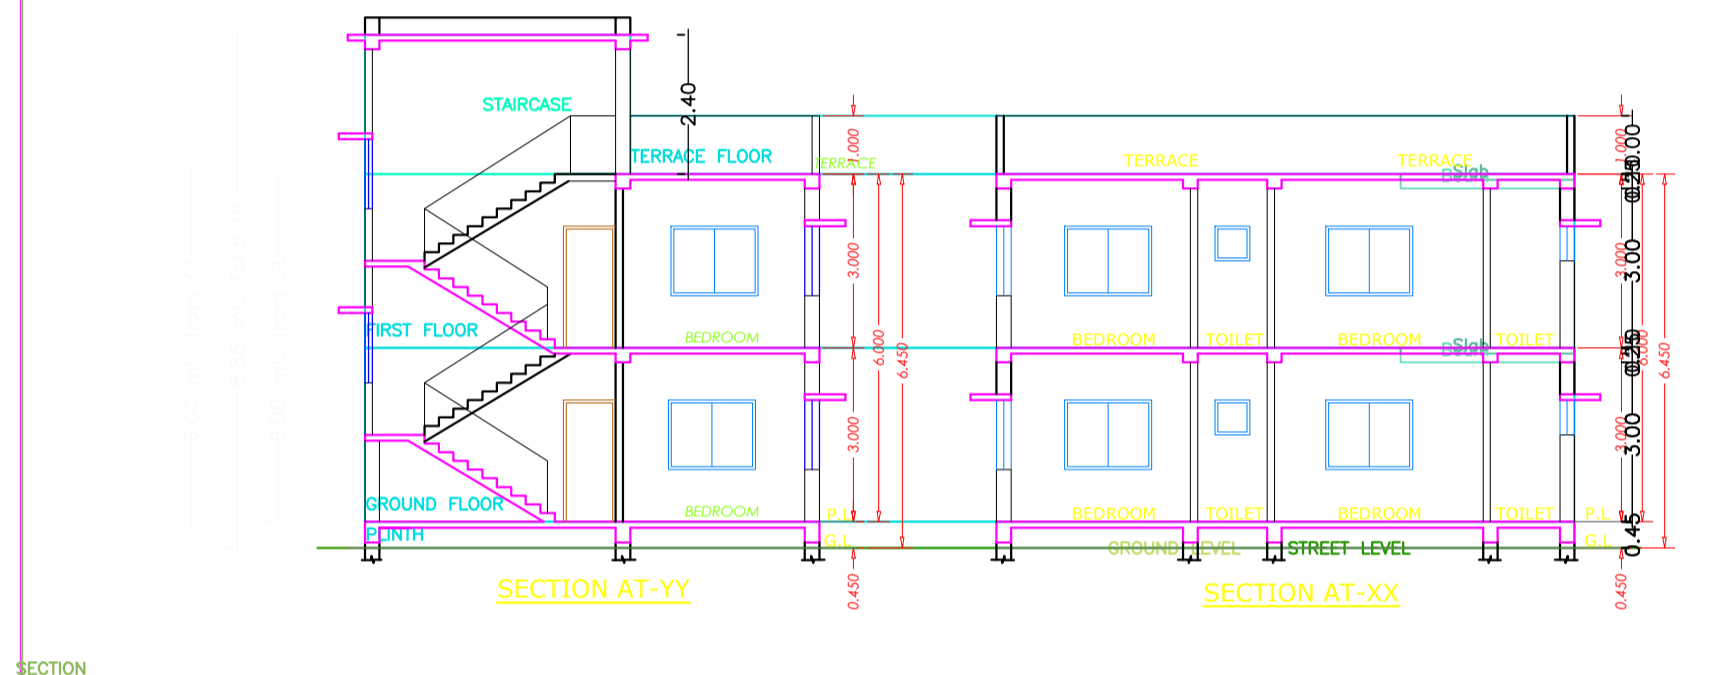

COLOR INDEX


PLOT BOUNDARY	Red
PROPOSED WORK (COVERGE AREA)	Green
EXISTING (To be retained)	Blue
EXISTING (To be demolished)	Yellow

Color Index:
FAR & Tenement Details (Table 4c-1)

Building	No. of Same Bldg	Total Built Up Area (Sq.mt.)	Proposed FAR Area (Sq.mt.)	Total FAR Area (Sq.mt.)	Trent (No.)
A (BUILDING G1)	1	141.42	141.42	141.42	01
Grand Total :	1	141.42	141.42	141.42	01

SCHEDULE OF DOORS AND WINDOWS

S.No	Type	Width	Height	Unit	Description
1	D	1.650	2.100	2.100	single flush corner door
2	D	0.975	2.100	2.100	single flush corner door
3	D1	0.900	2.100	2.100	single flush corner door
4	D2	0.750	2.100	2.100	single flush corner door
5	W	1.500	1.200	2.100	4 roof glazed shutter
6	W1	1.200	1.200	2.100	4 roof glazed shutter
7	V	0.600	0.600	2.100	ventilation

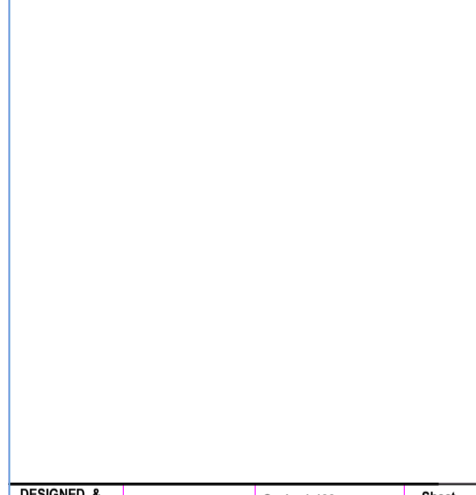


DESIGNED & CHECKED BY: _____ Scale: 1:100 Sheet: 01

DRAWN: _____ Date: _____

ISSUE ONLY FOR: _____

APPROVED: _____

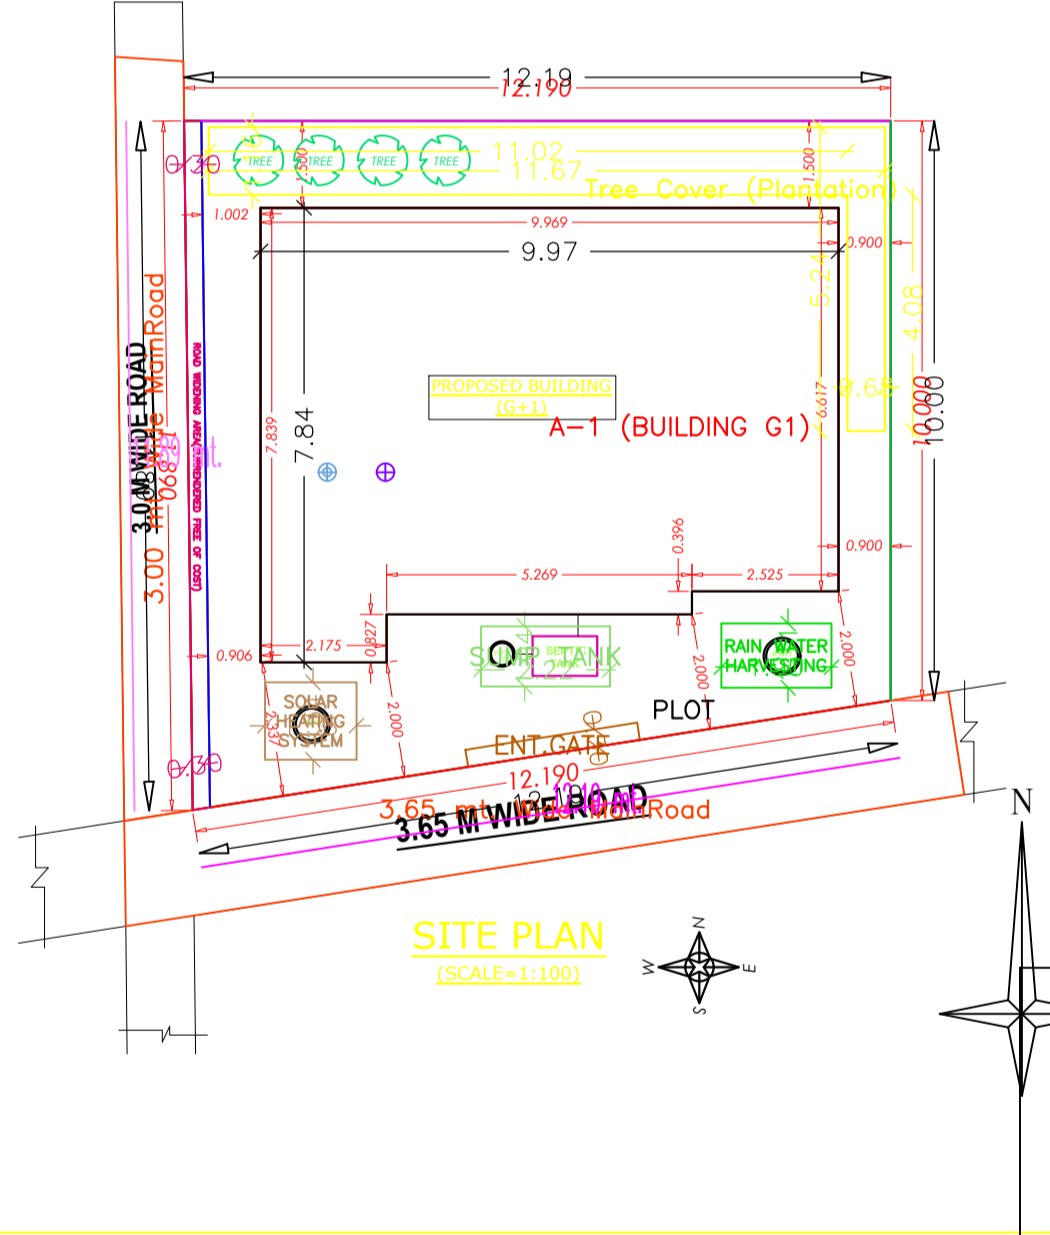

Building :A (BUILDING G1)

Floor Name	Total Built Up Area (Sq.mt.)	Proposed FAR Area (Sq.mt.)	Total FAR Area (Sq.mt.)	Trent (No.)
Ground Floor	70.71	70.71	70.71	01
First Floor	70.71	70.71	70.71	00
Terrace Floor	0.00	0.00	0.00	00
Total	141.42	141.42	141.42	01
Total Number of Same Buildings	1	-	-	-
Total :	141.42	141.42	141.42	01

SCHEDULE OF JOINERY:

BUILDING NAME	NAME	LENGTH	HEIGHT	NOS
A (BUILDING G1)	D2	0.75	2.10	04
A (BUILDING G1)	D1	0.90	2.10	05
A (BUILDING G1)	D	1.05	2.10	05
Total	-	-	-	14

SCHEDULE OF JOINERY:

BUILDING NAME	NAME	LENGTH	HEIGHT	NOS
A (BUILDING G1)	V	0.60	1.00	04
A (BUILDING G1)	W1	1.20	1.20	03
A (BUILDING G1)	W	1.50	1.20	10
Total	-	-	-	17

UnitBUA Table for Building :A (BUILDING G1)

FLOOR	Name	UnitBUA Type	UnitBUA Area	Carpet Area	No. of Rooms	No. of Tenement
GROUND FLOOR PLAN	SPLIT A	FLAT	141.42	136.56	6	1
Total	-	-	141.42	136.56	12	1