



DOOR WINDOW AND VENTILATION DETAIL						
S/No	TYPE	LENGTH	HEIGHT	SILL LEV.	LINTEL LEV.	DESCRIPTION
1	D	1.20M	2.10M	0.00	2.1	SOLID CORE FLUSH DOOR
2	D1	0.90M	2.10M	0.00	2.1	SOLID CORE FLUSH DOOR
3	D2	0.75M	2.10M	0.00	2.1	SOLID CORE FLUSH DOOR
4	W6	1.80M	1.20M	0.90	2.1	FULLY GLASSED STEEL WINDOW
5	W4	1.20M	1.20M	0.90	2.1	FULLY GLASSED STEEL WINDOW
6	W3	0.90M	1.20M	0.90	2.1	FULLY GLASSED STEEL WINDOW
7	Wk	0.90M	1.20M	0.90	2.1	FULLY GLASSED STEEL WINDOW
8	V	0.60M	0.60M	1.50	2.1	FULLY GLASSED VENTILATION


Note- this detail is applicable in all floor.

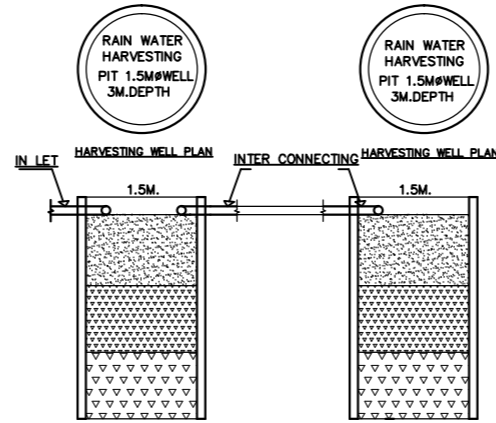


HARVESTING WELL SECTION

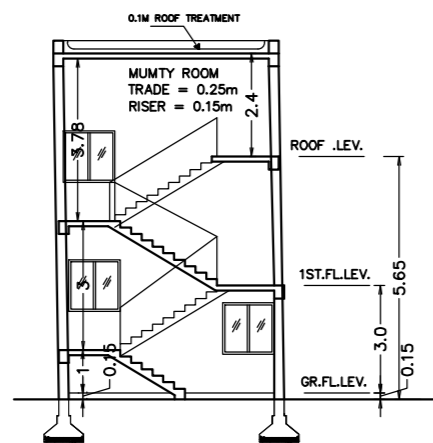

SECTION -X-X'  
SCALE : 1:100

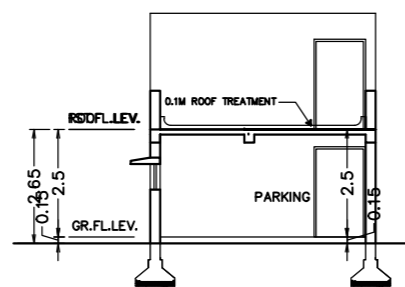

SECTION -Y-Y'  
SCALE : 1:100

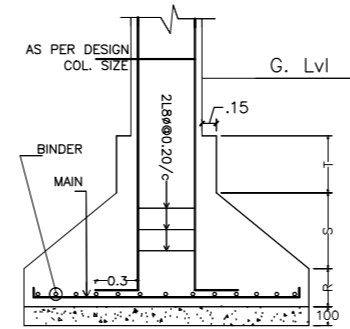

DETAIL OF COLUMN & FOOTING


AREA STATEMENT FOR RESIDENTIAL INDIVIDUAL BUILDING				
S/No.		EXISTING (In Sqm)	PROPOSED (In Sqm)	TOTAL (In Sqm)
1.	PLOT AREA	NIL	83.43	83.43
2.	GROUND COVERAGE	NIL	49.56	49.56
3.	GROUND FLOOR	NIL	15.27	15.27
4.	FIRST FLOOR	NIL	49.56	49.56
5.	SECOND FLOOR	NIL	49.56	49.56
6.	3RD FLOOR	NIL		
			TOTAL	114.39
7.	%GROUND COVERAGE	49.56/83.43 x100= 59.40 % < 70%		
8.	F.A.R. DETAIL	114.39 / 83.43 = 1.37		

**WATER CONSUMPTION CALCULATION**


- \* WATER REQUIRED PER PERSON - 130 Ltrs.
- \* TOTAL NUMBER OF PERSONS - 6
- \* WATER REQD. FOR 6 PERSONS - 6x130+10% = 858 Ltrs.
- \* PROVIDED - 1000 Ltrs.

**CALCULATION OF PARKING REQUIREMENTS**


- \* NO OF CAR PARKING REQD. - 1 Nos.
- \* AREA REQD. - 1x20 = 20 Sqm.
- \* PROVIDED - 34.43 Sqm

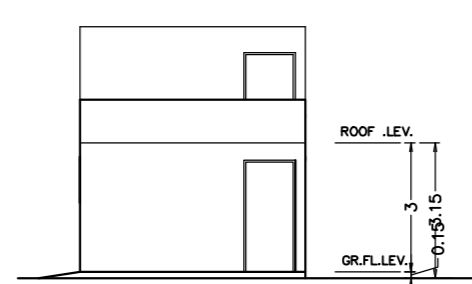


FRONT ELEVATION  
SCALE : 1:100

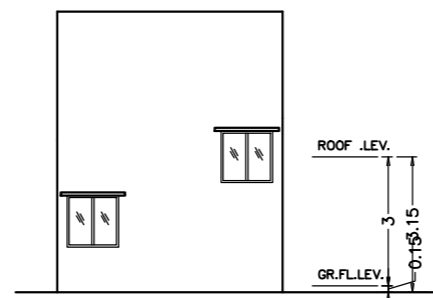


REAR ELEVATION  
SCALE : 1:100

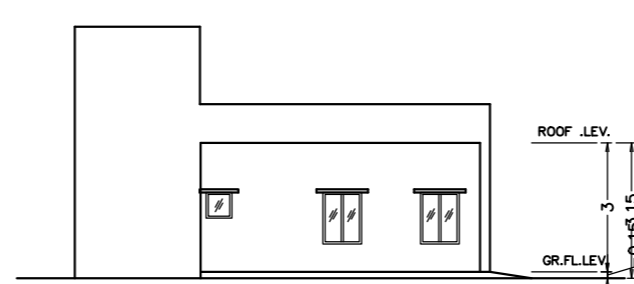


SIDE ELEVATION  
SCALE : 1:100

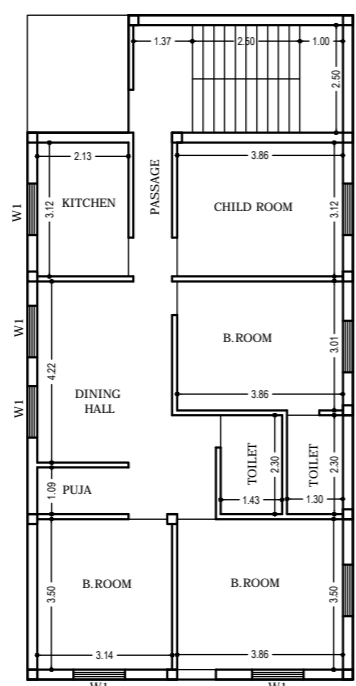

GROUND FLOOR PLAN  
SCALE : 1:100

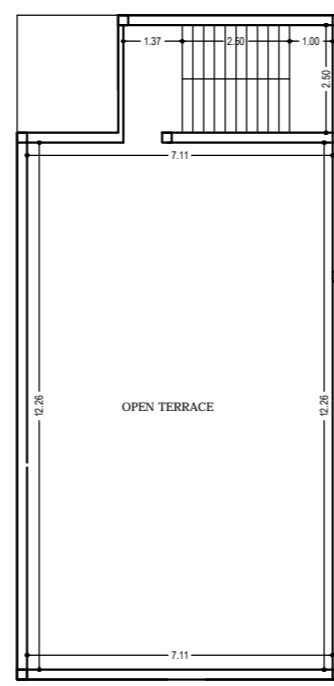

ROOF PLAN  
SCALE : 1:100

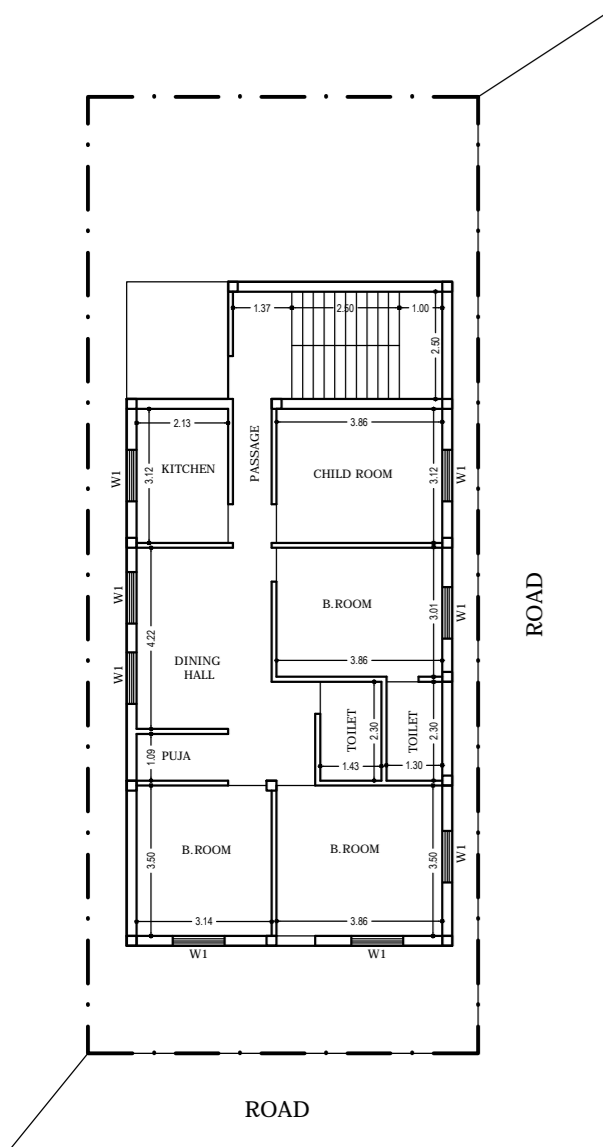

- NOTE:**
1. FOUNDATION & R.C.C. AS PER STRUCTURAL ENGG. SPECIFICATION
  2. ALL EXISTING STRUCTURE TO BE DEMOLISHED
  3. ALL DIMENSIONS IN Mtrs.
  4. DRAWING NOT TO BE SCALED

OFFICE USE

APPROVED:-

OWNER / POAH

Signature of Applicant:-

**GENERAL SPECIFICATION :-**

- FOUNDATION : PLAIN CEMENT CONCRETE AS PER DESIGN.
- : R.C.C. COLUMN FOOTING & COLUMN AS PER STRUCTURAL DESIGN.
- : R.C.C. COLUMN & BEAM AS PER STR. DESIGN.
- SUPER STRUCTURE: 23M.THK. EXT. WALL & 0.125M.THK. PARTITION WALL IN CEMENT MORTAR.
- : R.C.C. ROOF SLAB AS PER STRUCTURAL DESIGN.
- FLOOR : CERAMIC TILES FLOOR AND DADO.
- INTERNAL FINISH : CEMENT PLASTER FLOOR WITH P.O.P & O.B.D.
- SANITARY : VITROUS CHAINA CLAY SANITARY WARE G.I. PIPE WATER SUPPLY.
- : P.V.C PIPE FOR SEWAGE DISPOSAL.
- DOORS & WINDOW AS PER SCHEDULE.
- ELECTRICAL : COPPER WIRE WITH P.V.C. CONDUIT.

PROPOSED RESIDENTIAL BUILDING PLAN OF

SHEET No- 01 / 01