

SITE LAYOUT PAN

GENERAL NOTES:

- 1. THIS DRAWING IS AN EXCLUSIVE PROPERTY OF THE ARCHITECT.

 USE OF THIS DRAWING FOR ANY PURPOSE WITHOUT CONSENT IS STRICTLY PROHIBITED.
- 2. ARCHITECT SHALL NOT BE RESPONSIBLE OR LIABLE FOR ANY DEVIATION IN ANY RESPECT INCLUDING CHANGE IN DESIGN, VISUAL INTENT, SPECIFICATION OR CONSTRUCTION METHODOLOGY ETC. MADE WITHOUT SPECIFIC WRITTEN APPROVAL FROM THE
- 3. DO NOT SCALE THE DRAWING, READ ONLY.
- 4. ALL DIMENSIONS ARE IN FEET-INCHES [METERS] AND LEVELS & COORDINATES ARE IN FEET-INCHES UNLESS SPECIFIED OTHERWISE.
- 5. Ensure compliance with all local bye-laws, fire codes as well as national building code.
- 6. ALL CHAJJA SHALL HAVE DRIP MOULD & GROOVES UNDERNEATH ALL ALONG THE PERIPHERIES.
- 7. 50MM DAMP PROOF COURSE (1:2:4) TO BE PROVIDED AT PLINTH LEVEL.
- 8. 900MM PLINTH PROTECTION TO BE PROVIDED AROUND THE PERIPHERY OF BUILDING.
- . Contractor must check dimensions at site and incase of any discrepancies, inform the architect immediately.
- 10. THE CONTRACTOR SHALL CHECK THE ACTUAL OPENING SIZES AT SITE AND THE NUMBERS OF DOOR & WINDOW ETC. IN THE DRAWING BEFORE FABRICATING/PROCURING THE SAME.
- 11. HANDRAIL SHALL BE STAINLESS STEEL SS304 GRADE (UNO).
- 12. ANTI-TERMITE TREATMENT SHALL BE PROVIDED UNDER FLOOR AND JUNCTION OF WALLS AND FLOOR.
- 13. PLATFORM IN KITCHEN & CANTEEN SHALL BE OF 600MM WIDE AND 900MM ABOVE FINISHED FLOOR LEVEL. PLATFORM SHALL BE OF 18-20MM POLISHED GRANITE.
- 14. WATER PROOFING SHALL BE LAID AS PER SPECIFICATION.
- 15. FOR WORKERS TOILET, HEIGHT OF 5 INCHES(125MM) THICK BRICK PARTITION WALL(WC) SHALL BE 2400MM ABOVE FINISHED FLOOR LEVEL.
- 16. PLEASE REFER TO STRUCTURAL DRAWING FOR STRUCTURAL DIMENSIONS & DETAILS.
- 17. ALUMINUM PARTITION SHALL BE OF POWDER COATED ALUMINUM WITH FROSTING FILM GLASS PATTERN AS APPROVED BY THE CLIENT.


18. SEPTIC TANK CALCULATION:

TOTAL NO. OF PERSON = ...

TAKING 10% EXTRA = + =

STORAGE CAPACITY = 0.085/PERSON =

FOR GAS, 300MM ADDITIONAL FREE BOARD TO BE LEFT

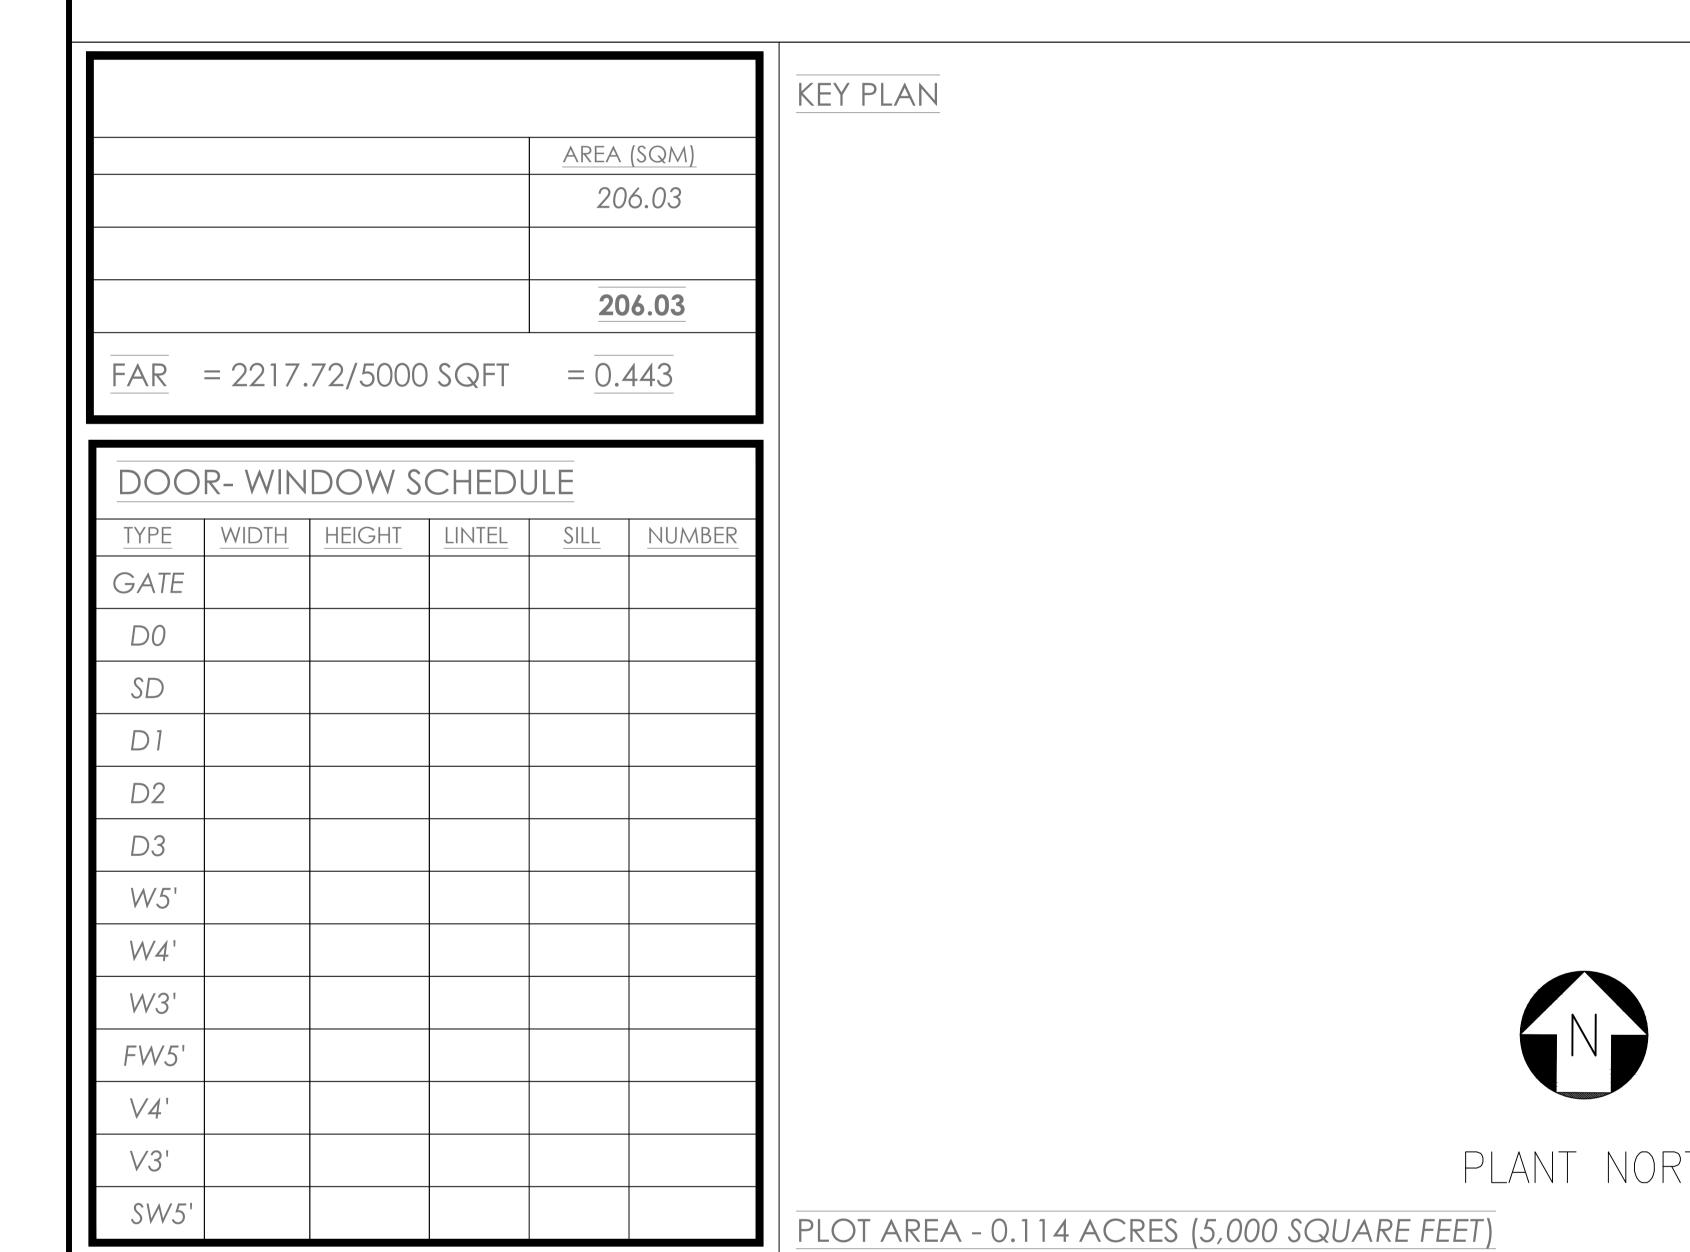

STRUCTURAL STABILITY CERTIFICATE

THIS IS TO CERTIFY THAT SEISMIC LOADS H STRUCTURE OF THE BUILDING.

THE DESIGN HAS BEEN DONE AS PER: IS 1893 / 1994 & IS 4326 / 1993.

SCALE: NOT TO SCALE

REV NO.	DATE	REVISIONS	BY	CHECK	APPROVE
1			GN	NJ	
2					
3					
DRAWING NO.: PNEWL/CD/DRD-0001			SHEET - 1 OF 1		


DRAWING TITLE:

CONCEPTUAL DRAWING | SITE PLAN

PRO IFO

PROPOSED INDUSTRIAL BUILDING FOR M/S NISHANT ENGINEERING WORKS AT PLOT NO. IX/A, LOHARDAGA INDUSTRIAL AREA, JHARKHAND

ARCHITECT'S SIGNATURI

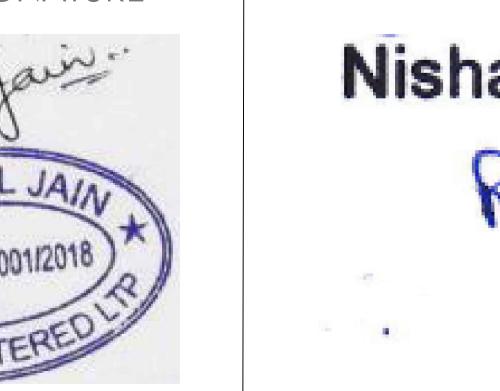

Nishant Engineering Works

Proprietor

BOTHRA DEVELOPERS

Architecture

Master Planning
Interior Designing

Project Management
Developers

Bothra Bhawan, Main Road, Hinoo, Ranchi-834002, Jharkhand